HIGH COURT OF AUSTRALIA LEVEL 1 PROPOSED WORKS FOR A PWDWC

Drawing List					
Sheet Number	Drawing Name	Current Revision	Date		
A000	COVER SHEET	С	10/08/2021		
A001	SITE PLAN	В	23/07/2021		
A005	SPECIFICATION NOTES 01	A	23/07/2021		
A007	FIXTURES & FINISHES	A	23/07/2021		
A010	EXISTING FLOOR PLAN	В	23/07/2021		
A050	DEMOLITION PLAN	В	23/07/2021		
A101	FLOOR PLAN NEW WORKS	С	23/07/2021		
A110	RCP EXISTING	В	10/08/2021		
A115	RCP DEMOLITION	В	10/08/2021		
A120	RCP NEW WORKS	С	10/08/2021		
A210	SECTIONS	A	10/08/2021		
A300	DETAIL ELEVATIONS FEMALE REST ROOM EXISTING	В	23/07/2021		
A301	DETAIL ELEVATIONS ACCESSIBLE TOILET EXISTING	В	23/07/2021		
A305	DETAIL ELEVATIONS FEMALE REST ROOM DEMOLITION	В	23/07/2021		
A306	DETAIL ELEVATIONS PARENTS ROOM DEMOLITION	В	23/07/2021		
A310	DETAIL ELEVATIONS NEW PWDWC	С	23/07/2021		
A311	DETAIL ELEVATIONS NEW PARENTS ROOM	В	23/07/2021		
A325	DETAIL SECTIONS 01				
A999	SAFETY IN DESIGN REPORT	A	23/07/2021		







NOTE: DO NOT SCALE OFF DRAWING

AMENDMENTS

A 22/06/2021 INITIAL ISSUE

B 23/07/2021 ISSUED FOR TENDER

C 10/08/2021 ISSUED FOR TENDER

ARCHITECT EMAA

Eric Martin & Associates 10/68 Jardine Street KINGSTON ACT 2604 Ph 02 6260 6395 Fax 02 6260 6413 emaa@emaa.com.au Eric Martin Registered Architect ACT 376 VIC 5150 NSW 5991 WA 1663 QLD 3391

CLIENT HIGH COURT OF AUSTRALIA

HIGH COURT OF AUSTRALIA
LEVEL 1 PWDWC

DRAWING
TITLE
COVER SHEET

CADFILE
V:AProjects 2020/20017 High Court of Australia\l Tendering\20017 Level
HCA PWDWC TENDER.rvt

SCALE
1:500@A3
PM


DATE
10/08/2021
CHECKED
EM

CAUSTING
DRAWN
PM

ISSUE/ REVISION
TENDER C

DWG NO
EM

20017-A000/C

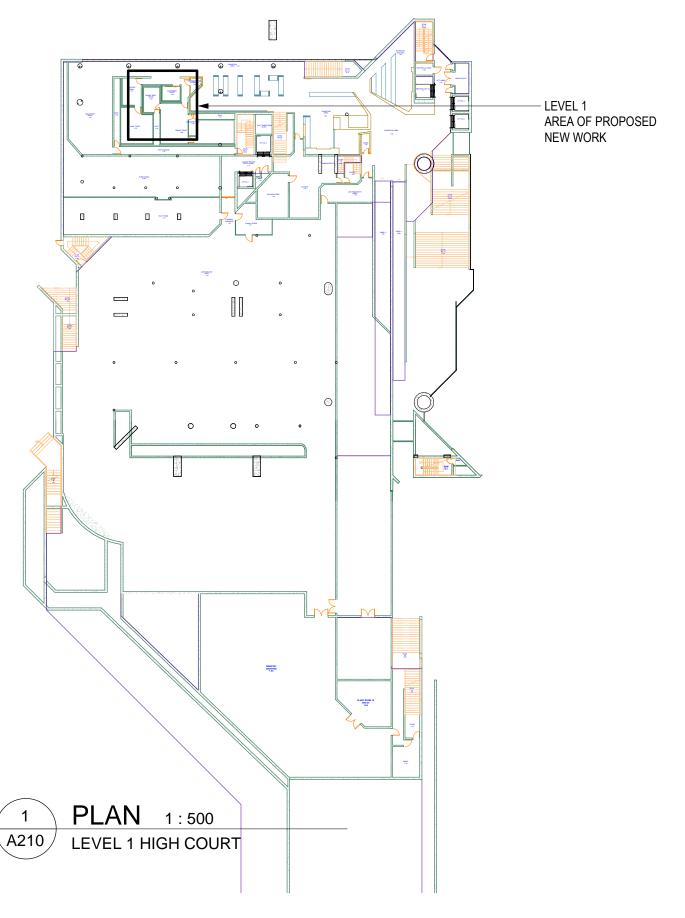



NOTE: DO NOT SCALE OFF DRAWING

AMENDMENTS

A 22/06/2021 INITIAL ISSUE B 23/07/2021 ISSUED FOR TENDER ARCHITECT

EMAA

Eric Martin & Associates
10/68 Jardine Street KINGSTON ACT 2604
Ph 02 6260 6395 Fax 02 6260 6413
emaa@emaa.com.au

Eric Martin Registered Architect
ACT 376 VIC 5150 NSW 5991 WA 1663 QLD 3391

CLIENT HIGH COURT OF AUSTRALIA

HIGH COURT OF AUSTRALIA
LEVEL 1 PWDWC

DRAWING

TITLE

SITE PLAN

CADRILE
VAProjects 2020/20017
HCA PWDWC TENDER
SCALE
1:500@A3

DATE
23/07/2021

CHECKED
EM

CADFILE
V:\Projects 2020\20017 High Court of Australia\l Tendering\20017 Level
HCA PWDWC TENDER.rvt

 SCALE
 DRAWN

 1:500@A3
 PM

 DATE
 ISSUE/ REVISION

 23/07/2021
 TENDER B

 CHECKED
 DWG No

 EM
 20017-A001/B

SECTION 02050 DEMOLITION

DEMOLISH ALL FIXTURES AND FINISHES INCLUDING THE CEILING AS PER DEMOLITION DRAWINGS, INCLUDING MECHANICAL, ELECTRICAL AND HYDRAULIC ENGINEERS SPECIFICATIONS RETAIN PLUMBING FOR ADAPTION AS SPECIFIED IN THE HYDRAULIC ENGINEERS SPECIFICATION

SECTION 02150 ASBESTOS REMOVAL

IF ASBESTOS MATERIAL IS DISCOVERED ON THE SITE AFTER WORK HAS STARTED, THE WORK WILL BE CEASED IMMEDIATELY AND LICENSED PERSONS ENGAGED TO REMOVE ASBESTOS-CONTAINING MATERIAL, CERTIFY ITS REMOVAL AND RE-ISSUE AN ASBESTOS CLEARANCE CERTIFICATE.

SECTION 02510 WATER DISTRIBUTION

AS PER HYDRAULIC ENGINEERS SPECIFICATIONS

SECTION 02530 SANITARY SEWERAGE

AS PER HYDRAULIC ENGINEERS SPECIFICATIONS

SECTION 08460 AUTOMATIC SLIDING DOOR ASSEMBLIES

PROVIDE A SOLID CORE DOOR WITH AUTOMATIC POWER CONTROL. PROVIDE POWER AS PER THE MANUFACTURERS SPECIFICATIONS. INCLUDE THE DORMAKABA DOOR CONTROLLERS AS SHOWN ON THE ARCHITECTURAL PLANS AND ELEVATIONS. PROVIDE POWER TO THE DOOR CONTROLLERS AND DOOR. PAINT FINISH DOOR AND ENSURE THE IS SUITABLE LUMINANCE CONTRAST BETWEEN THE DOOR AND THE WALL OR WALL AND DOOR FRAME. DEMOLISH THE EXISTING WALL AS NECESSARY TO INSTALL THE NEW DOOR. ALL WORK TO BE CONDUCTED AS PER RELEVANT AUSTRALIAN STANDARDS

SECTION 08850 MIRRORS

NEW SOLID GLASS MIRROR BONDED TO BACKING WITH NO FRAME 700MM WIDE AND 950MM HIGH TO COMPLY WITH AS1428.1 TO BE INSTALLED ON THE WALL ABOVE THE BASIN. GROUND AND POLISHED ON EXPOSED EDGES. FIX TO THE WALL WITH APPROPRIATE FIXINGS AS PER MANUFACTURERS SPECIFICATIONS.

SECTION 09300 CERAMIC TILE

SUPPLY AND INSTALL CERAMIC TILE WORK INCLUDING BUT NOT LIMITED TO THE: SUITABLE PREPARATION OF SURFACES BEFORE TILING OR BEDDING AND BEDDING SCREEDS WITH A SUITABLE WATERPROOF MEMBRANE. ALSO INSTALL WALL TILES AND FLOOR TILES. CLEAN FINISHED TILED SURFACES AND FOR TILE SPECIFICATIONS REFER TO FINISHES SCHEDULE. PROVIDE SLOPE ON THE FLOOR TO THE FLOOR WASTE. INSTALL GROUT AND ENSURE ALL WORK IS UNDERTAKEN IN ACCORDANCE OF AUSTRALIAN STANDARDS.

SECTION 09500 SUSPENDED CEILING

SUPPLY AND INSTALL A COMPLETE PLASTERBOARD SUSPENDED CEILING FOR THE PWDWC. COORDINATE WITH MECHANICAL AND ELECTRICAL SERVICES. INSTALL A 50mm CORNICE.

SECTION 09910 PAINTING

ALL EXPOSED PLASTERBOARD IS TO BE PRIMED AND PAINTED, COLOUR TO BE CONFIRMED. ALL CEILINGS AND CORNICES ARE TO BE PRIMED & PAINTED WITH CEILING WHITE. PAINT DOOR & FRAME & WALL IN FEMALE TOILET

SECTION 15150 FLOOR DRAINS

BUILD IN FLOOR WASTE WITH TILES TO SLOPE TOWARD THE FLOOR WASTE.

SECTION 15782 MECHANICAL SERVICES

AS PER MECHANICAL ENGINEERS SPECIFICATIONS

SECTION 16350 ELECTRICAL INSTALLATIONS

AS PER ELECTRICAL ENGINEERS SPECIFICATIONS

SECTION 16515 LOW VOLTAGE LIGHTING

AS PER ELECTRICAL ENGINEERS SPECIFICATIONS

SECTION 16710 COMMUNICATION CABLING

AS PER ELECTRICAL ENGINEERS SPECIFICATIONS

NOTE: DO NOT SCALE OFF DRAWING

AMENDMENTS
A 23/07/2021 ISSUED FOR TENDER

ARCHITECT

Eric Martin & Associates
10/68 Jardine Street KINGSTON ACT 2604
Ph 02 6260 6395 Fax 02 6260 6413
emaa@emaa.com.au
Eric Martin Registered Architect
ACT 376 VIC 5150 NSW 5991 WA 1663 QLD 3391

HIGH COURT OF

PROJECT
HIGH COURT OF AUSTRALIA
LEVEL 1 PWDWC

DRAWING
TITLE

SPECIFICATION NOTES 01

CADFILE
V:\Projects 2020\20017 High Court of Australia\l Tendering\20017 Level
HCA PWDWC TENDER.rvt

SCALE
1:100@A3

DATE

DRAWN
PM

ISSUE/ REVISION

B1: CAROMA BASIN OPAL 720 WALL BASIN RIGTH HAND SHELF

MX: CAROMA ACQUA CARE BASIN MIXER 90989C5A

C: 50mm COVED PLASTER CORNICE PAINTED CEILING WHITE

GPO: CLIPSAL 2000 SERIES - POWER TO AUTO DOOR TO COMPLY WITH AS3000 & AUTO DOOR MANUFACTURERES

SPECIFICATIONS

DOOR2: SOLID CORE DOOR 920mm LEAF MINIMUM AUTO OPERATED

FW: FLOOR WASTE ART AUSTRALIA 316 STAINLESS STEEL 100mm SQUARE

GR1: MAIN GRABRAIL CAROMA CAARE SUPPORT GRABRAIL - 140 DEGREE ANGLED 870 X 700 LEFT HAND 687466SS

GR2: 300mm GRABRAIL CAROMA CARE SUPPORT GRABRAIL - 300mm STRAIGHT 687471SS

HK: HOOK RBA1622-120

MD: CLIPSAL MOTION DETECTOR SWITCH WITH FAN AS PER ELECTRICAL ENGINEERS SPECIFICATIONS

M1: MIRROR 700mm x 1050mm

M2: MIRROR 1470mm x 890mm EXISTING

PAN1: CAROMA CARE 800 CLEANFLUSH WALL FACED SUITE WITH BACKREST, CONTRASTING ANTHRACITE GREY

SEAT S TRAP ACCESSIBLE TO AS1428.1 PAN # 901920BAG

PPB: PAINTED PLASTERBOARD COLOR TO BE CONFIRMED

PTD: PAPER TOWEL DISPENSER METLAM STAINLESS STEEL ML725SS_MK2

SD: SOAP DISPENSER METLAM STAINLESS STEEL ML605BS

T1: 200mm x 100mm x 6mm WALL TILES AS PER HIGH COURT NEW WORKS REQUIREMENTS TO BE CONFIRMED 100mm x 100mm FLOOR TILES AS PER HIGH COURT NEW WORKS REQUIREMENTS TO BE CONFIRMED

TPH: TOILET PAPER HOLDER METLAM 700 SS TRH

WPTB: WASTE PAPER TOWEL BIN - NOT TO ENROACH INTO CIRCULATION SPACE

BCT: BABY CHANGE TABLE HORIZONTAL KOALA KARE BABY CHANGE STATION KB200-SS

HD: DYSON AIR BLADE V HAND DRYER

ADOE: DORMAKABA AUTO DOOR OPERATION PAD EXTERNAL 205mm HIGH 230mm WIDE ADOI: DORMAKABA AUTO DOOR OPERATION PAD INTERNAL 265mm HIGH 230mm WIDE

SG1: BRAILLE TACTILE SIGNS PWDWC SIGN PART NUMBER BTS11LHn-AL-blu

SG2: BRAILLE TACTILE SIGNS UNISEX BABY CHANGE ROOM PART NUMBER BTS162n-blu

NOTE: DO NOT SCALE OFF DRAWING

A 23/07/2021 ISSUED FOR TENDER


AMENDMENTS

ARCHITECT EMA

Eric Martin & Associates
10/68 Jardine Street KINGSTON ACT 2604
Ph 02 6260 6395 Fax 02 6260 6413
emaa@emaa.com.au
Eric Martin Registered Architect
ACT 376 VIC 5150 NSW 5991 WA 1663 QLD 3391

CLIENT
HIGH COURT OF
AUSTRALIA

CADFILE
V:\Projects 2020\20017 High Court of Australia\\ Tendering\20017 Level
HCA PWDWC TENDER.rvt HIGH COURT OF AUSTRALIA SCALE DRAWN LEVEL 1 PWDWC 1:100@A3 PMDRAWING DATE ISSUE/ REVISION 23/07/2021 TITLE TENDER A **CHECKED** DWG No **FIXTURES & FINISHES** ΕM 20017-A007/A

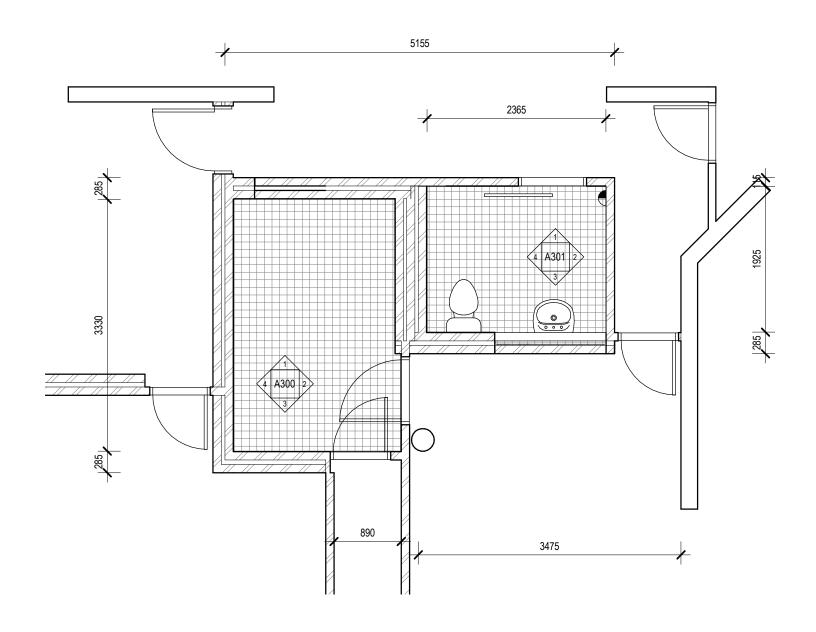





AMENDMENTS ARCHITECT

A 22/06/2021 INITIAL ISSUE B 23/07/2021 ISSUED FOR TENDER

Eric Martin & Associates
10/68 Jardine Street KINGSTON ACT 2604
Ph 02 6260 6395 Fax 02 6260 6413
emaa@emaa.com.au
Eric Martin Registered Architect
ACT 376 VIC 5150 NSW 5991 WA 1663 QLD 3391

CLIENT HIGH COURT OF AUSTRALIA


HIGH COURT OF AUSTRALIA LEVEL 1 PWDWC DRAWING TITLE **EXISTING FLOOR PLAN**

SCALE 1:50@A3 DATE 23/07/2021

CHECKED

ΕM



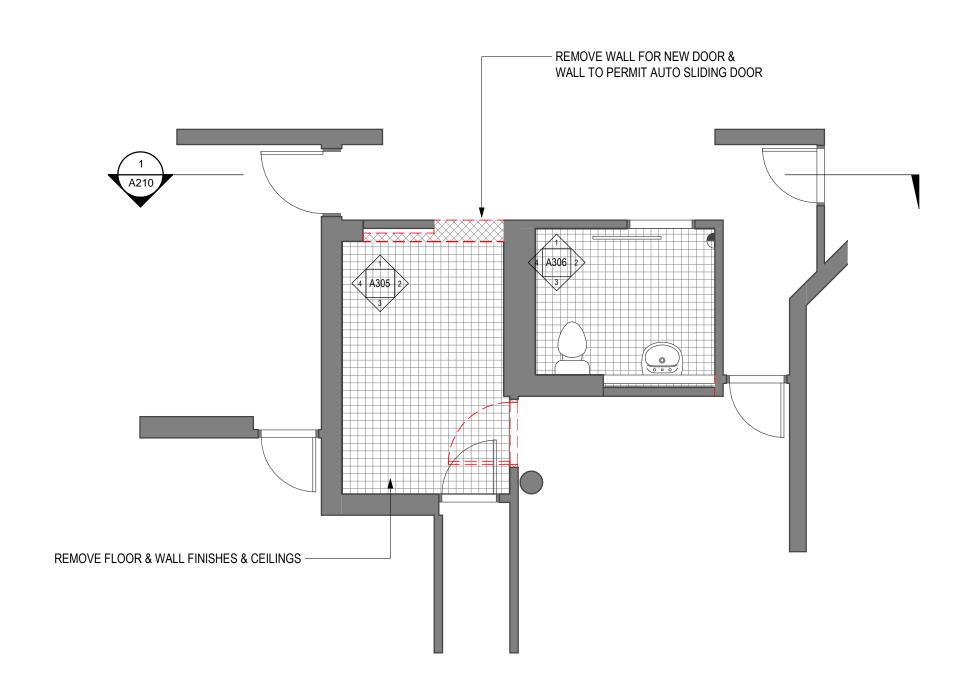





AMENDMENTS

A 22/06/2021 INITIAL ISSUE B 23/07/2021 ISSUED FOR TENDER ARCHITECT

EMAA

Eric Martin & Associates
10/68 Jardine Street KINGSTON ACT 2604
Ph 02 6260 6395 Fax 02 6260 6413
emaa@emaa.com.au
Eric Martin Registered Architect
ACT 376 VIC 5150 NSW 5991 WA 1663 QLD 3391

CLIENT HIGH COURT OF AUSTRALIA

HIGH COURT OF AUSTRALIA
LEVEL 1 PWDWC
DRAWING
TITLE
DEMOLITION PLAN

NOTE: DO NOT SCALE OFF DRAWING

CADFILE
V:Projects 2020\20017 High Court of Australia\l Tendering\20017 Level
HCA PWDWC TENDER.rvt

SCALE

DRAWN


 1:50@A3
 PM

 DATE
 ISSUE/ REVISION

 23/07/2021
 TENDER B

 CHECKED
 DWG No

 EM
 20017-A050/B

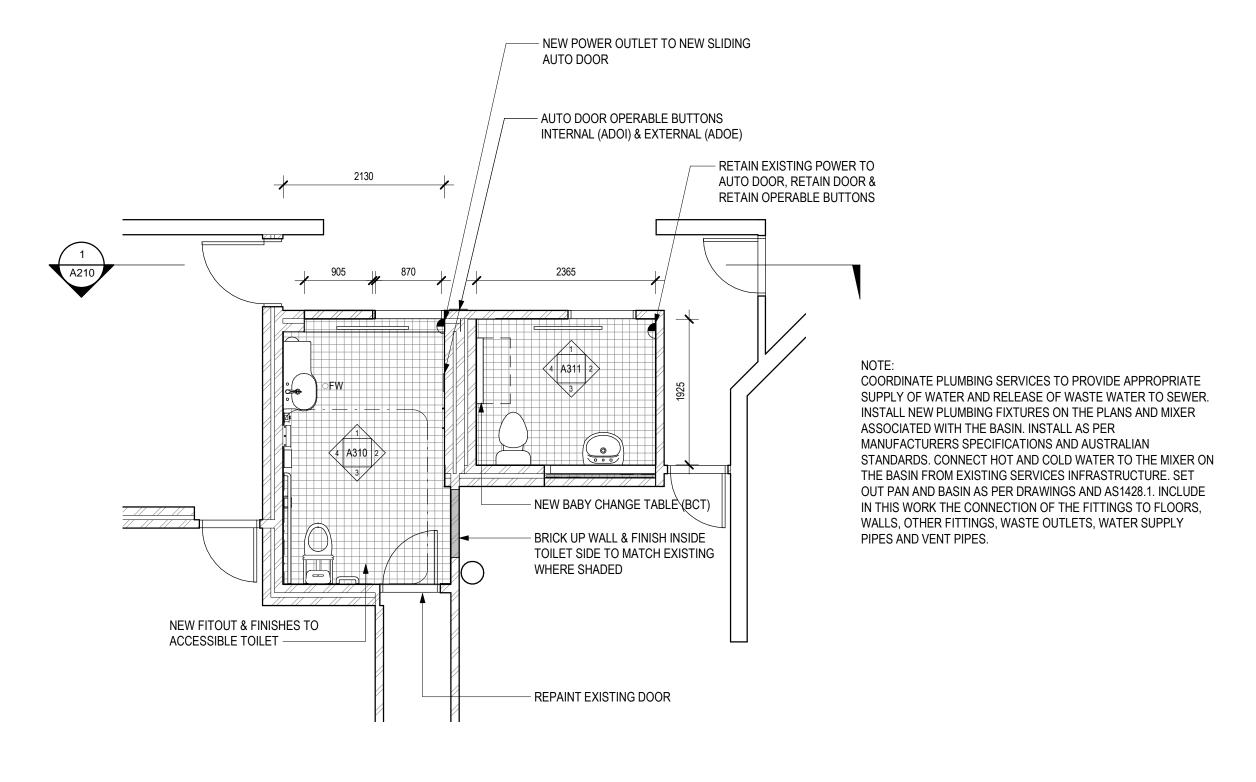





NOTE: DO NOT SCALE OFF DRAWING

AMENDMENTS

A 22/06/2021 INITIAL ISSUE

B 06/07/2021 GENERAL AMENDMENTS WA C 23/07/2021 ISSUED FOR TENDER

55: 22: 11 1,2007/80/001

ARCHITECT

Eric Martin & Associates 10/68 Jardine Street KINGSTON ACT 2604 Ph 02 6260 6395 Fax 02 6260 6413 emaa@emaa.com.au Eric Martin Registered Architect ACT 376 VIC 5150 NSW 5991 WA 1663 QLD 3391


HIGH COURT OF **AUSTRALIA**

HIGH COURT OF AUSTRALIA LEVEL 1 PWDWC
DRAWING
TITLE

FLOOR PLAN NEW WORKS

CADFILE
V:\Projects 2020\20017 High Court of Australia\l Tendering\20017 Level
HCA PWDWC TENDER.rvt SCALE DRAWN

1:50@A3 DATE ISSUE/ REVISION 23/07/2021 TENDER C CHECKED DWG No ΕM 20017-A101/C

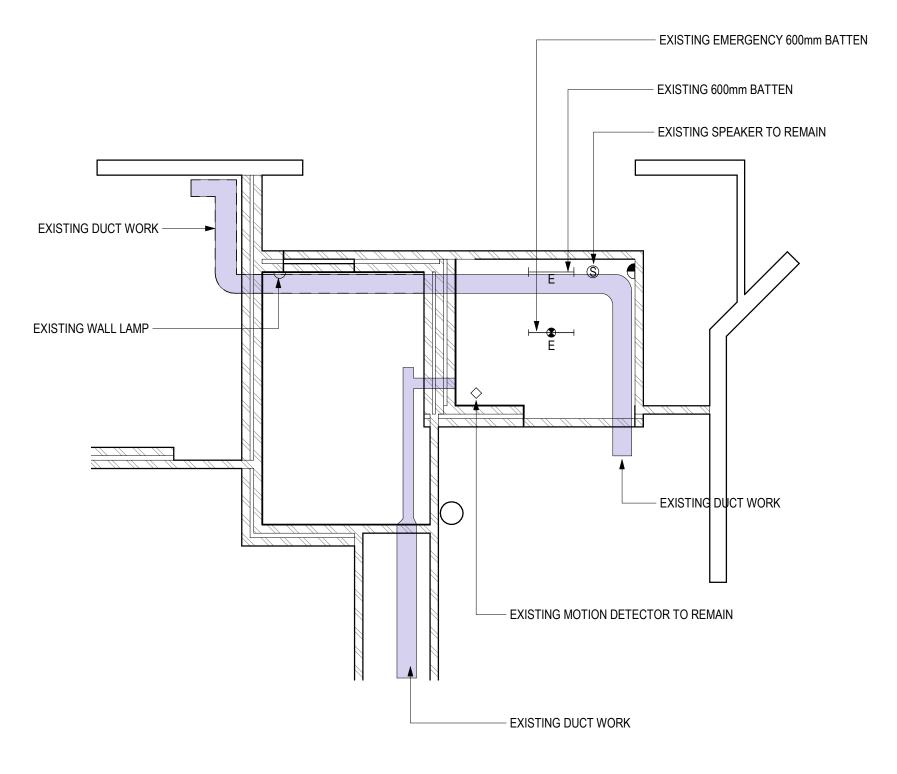





AMENDMENTS

A 23/07/2021 ISSUED FOR TENDER B 10/08/2021 ISSUED FOR TENDER ARCHITECT

EMAA

Eric Martin & Associates
10/68 Jardine Street KINGSTON ACT 2604
Ph 02 6260 6395 Fax 02 6260 6413
emaa@emaa.com.au
Eric Martin Registered Architect
ACT 376 VIC 5150 NSW 5991 WA 1663 QLD 3391

CLIENT HIGH COURT OF AUSTRALIA

HIGH COURT OF AUSTRALIA
LEVEL 1 PWDWC

DRAWING
TITLE

RCP EXISTING

NOTE: DO NOT SCALE OFF DRAWING


CADFILE
V:\Projects 2020\20017 High Court of Australia\\ Tendering\20017 Level
HCA PWDWC TENDER.rvt

SCALE
1:50@A3
PM

DATE
ISSUE/ REVISION
10/08/2021
TENDER B

CHECKED
DWG No
EM

20017-A110/B

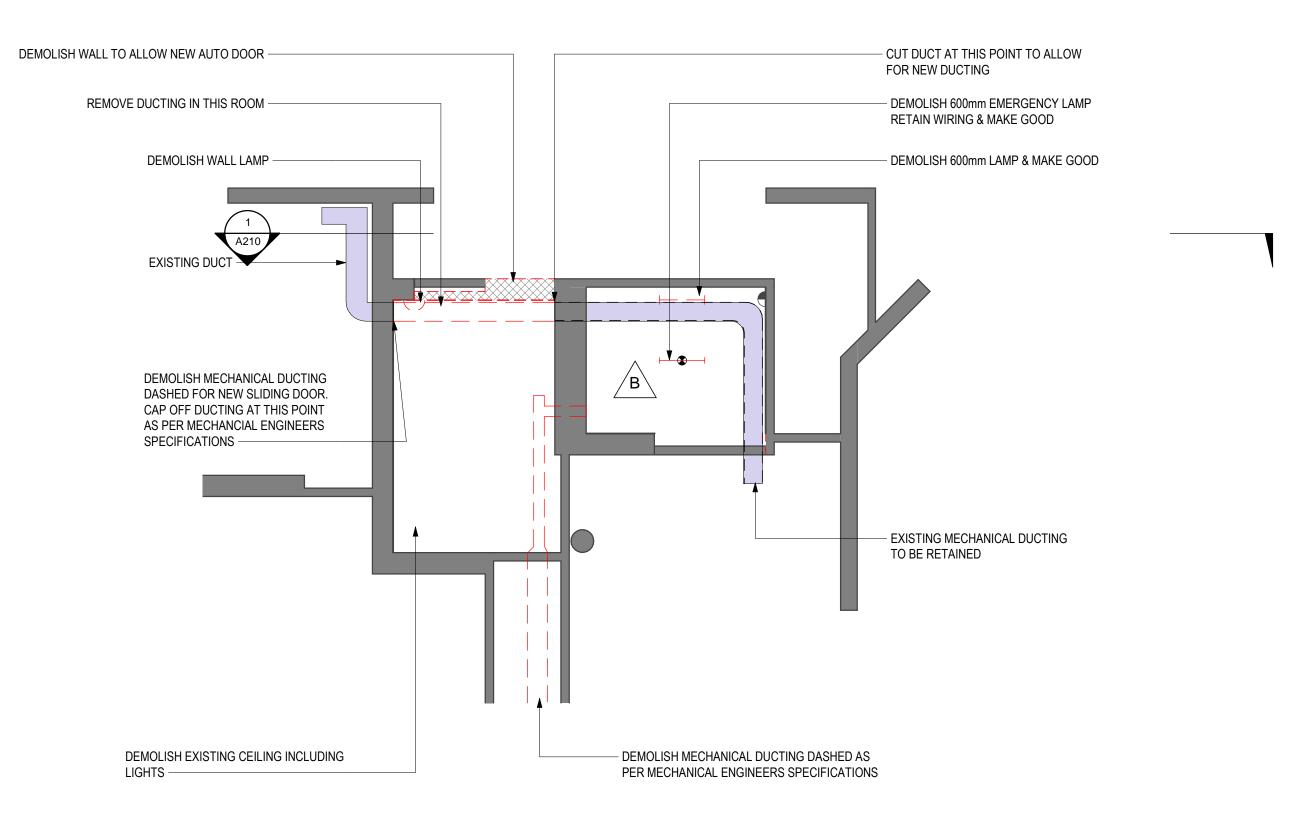





NOTE: DO NOT SCALE OFF DRAWING

AMENDMENTS

A 23/07/2021 ISSUED FOR TENDER B 10/08/2021 ISSUED FOR TENDER **ARCHITECT**



Eric Martin & Associates
10/68 Jardine Street KINGSTON ACT 2604
Ph 02 6260 6395 Fax 02 6260 6413
emaa@emaa.com.au
Eric Martin Registered Architect
ACT 376 VIC 5150 NSW 5991 WA 1663 QLD 3391

CLIENT HIGH COURT OF AUSTRALIA


PROJECT
HIGH COURT OF AUSTRALIA LEVEL 1 PWDWC
DRAWING TITLE

RCP DEMOLITION

CADFILE
V:\Projects 2020\20017 High Court of Australia\\ Tendering\20017 Level
HCA PWDWC TENDER.rvt

SCALE DRAWN
1:50@A3 PM

DATE ISSUE/ REVISION
10/08/2021 TENDER B
CHECKED DWG No
EM 20017-A115/B

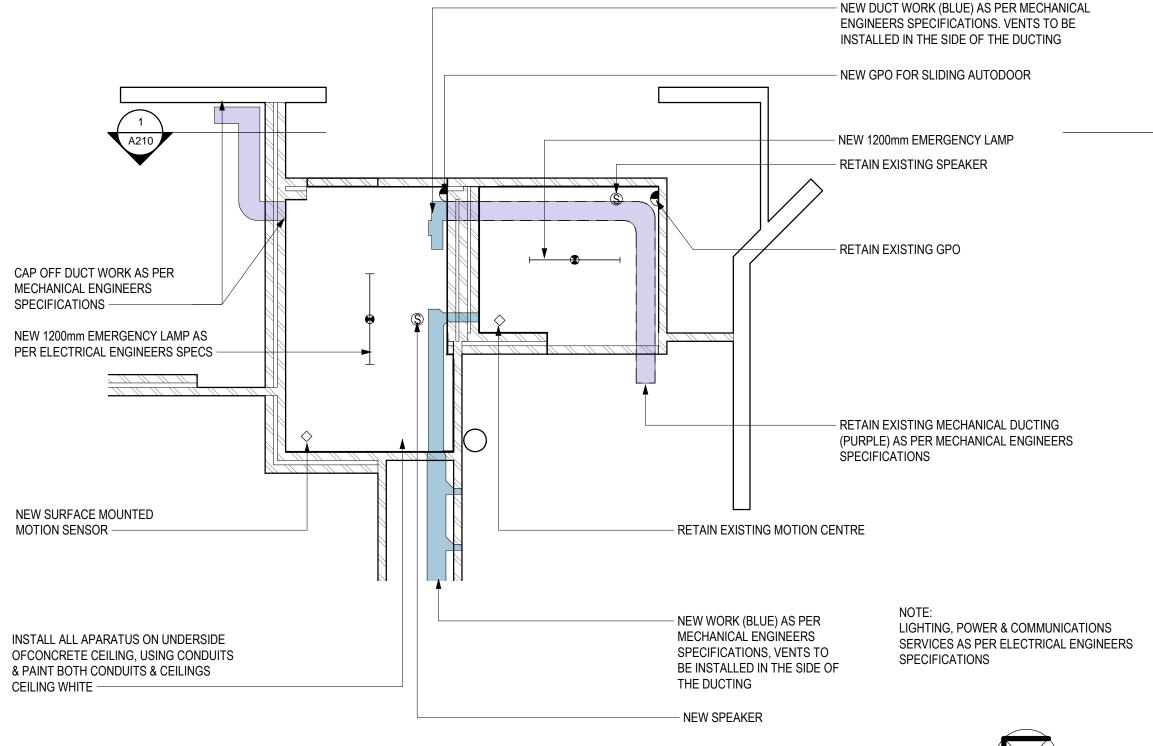



AMENDMENTS

A 16/07/2021 INITIAL ISSUE

B 23/07/2021 ISSUED FOR TENDER

C 10/08/2021 ISSUED FOR TENDER

ARCHITECT

EMAA


Eric Martin & Associates
10/68 Jardine Street KINGSTON ACT 2604
Ph 02 6260 6395 Fax 02 6260 6413
emaa@emaa.com.au
Eric Martin Registered Architect
ACT 376 VIC 5150 NSW 5991 WA 1663 QLD 3391


CLIENT
HIGH COURT OF
AUSTRALIA

PROJECT
HIGH COURT OF AUSTRALIA
LEVEL 1 PWDWC
DRAWING
TITLE

RCP NEW WORKS

NOTE: DO NOT SCALE OFF DRAWING

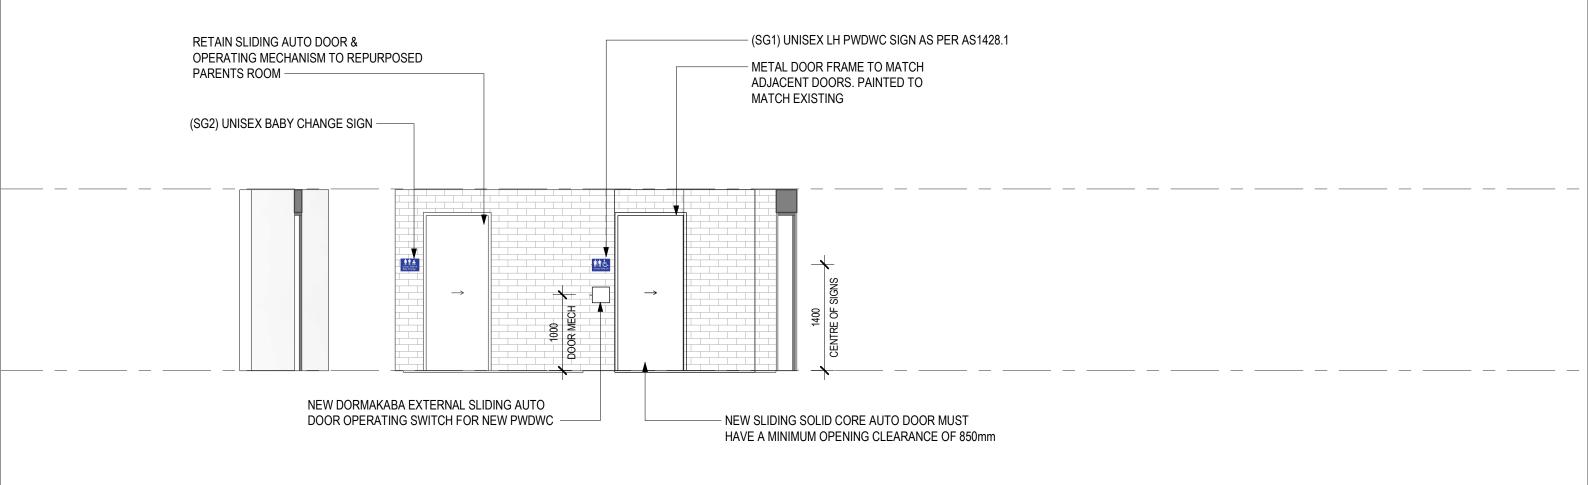

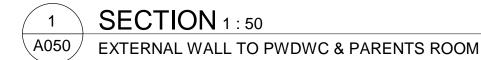

NOTE: DO NOT SCALE OFF DRAWING

08/2021 1:52:37 PM

AMENDMENTS

A 10/08/2021 ISSUED FOR TENDER

ARCHITECT


EMAA

Eric Martin & Associates
10/68 Jardine Street KINGSTON ACT 2604
Ph 02 6260 6395 Fax 02 6260 6413
emaa@emaa.com.au


Eric Martin Registered Architect
ACT 376 VIC 5150 NSW 5991 WA 1663 QLD 3391

HIGH COURT OF AUSTRALIA

PROJECT HIGH COURT OF AUSTRALIA	CADFILE V:\Projects 2020\20017 High Court of Australia\l Tendering\20017 Level 1 HCA PWDWC TENDER.rvt		
LEVEL 1 PWDWC	SCALE 1:50@A3	DRAWN PM	
DRAWING	DATE	ISSUE/ REVISION	
TITLE	10/08/2021	TENDER A	
SECTIONS	CHECKED	DWG No	
020110110	EM	20017-A210/A	

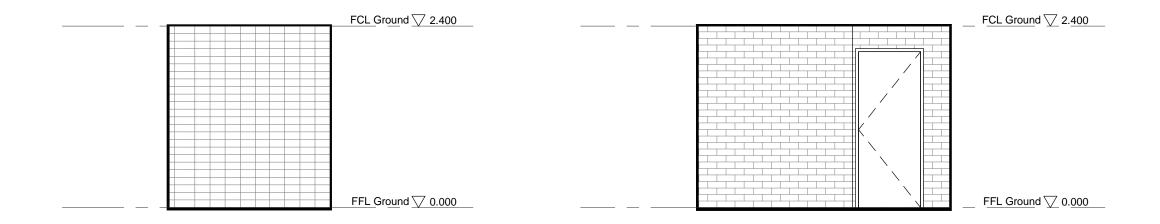

ELEVATION 1 ELEVATION 2

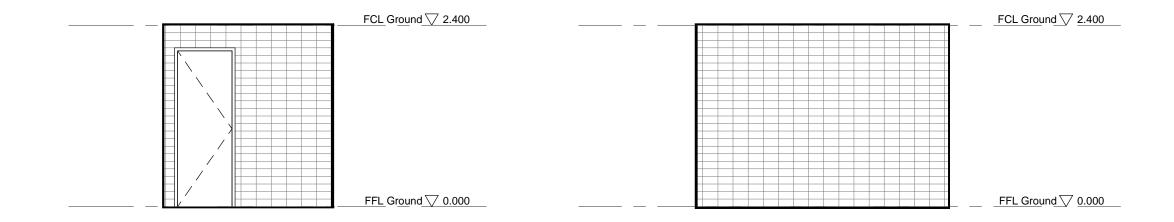

ELEVATION3 ELEVATION4



ARCHITECT

EMAA

Eric Martin & Associates
10/68 Jardine Street KINGSTON ACT 2604
Ph 02 6260 6395 Fax 02 6260 6413
emaa@emaa.com.au

Eric Martin Registered Architect
ACT 376 VIC 5150 NSW 5991 WA 1663 QLD 3391

CLIENT HIGH COURT OF AUSTRALIA PROJECT
HIGH COURT OF AUSTRALIA
LEVEL 1 PWDWC

DRAWING
TITLE
DETAIL ELEVATIONS FEMALE REST ROOM
EXISTING

CADFILE
V:\Projects 2020\20017 High Court of Australia\l Tendering\20017 Level
HCA PWDWC TENDER.rvt

NOTE: DO NOT SCALE OFF DRAWING

 SCALE
 DRAWN


 1:50@A3
 PM


 DATE
 ISSUE/ REVISION

 23/07/2021
 TENDER B


 CHECKED
 DWG No

 EM
 20017-A300/B

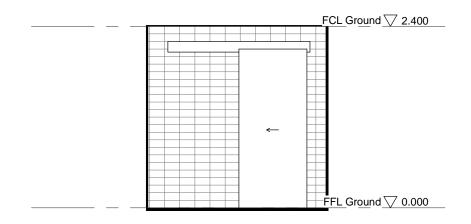


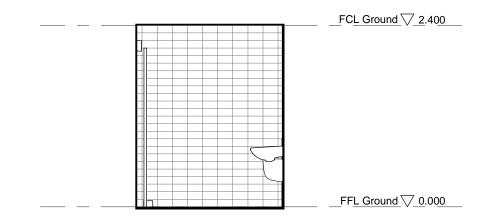

ELEVATION 1

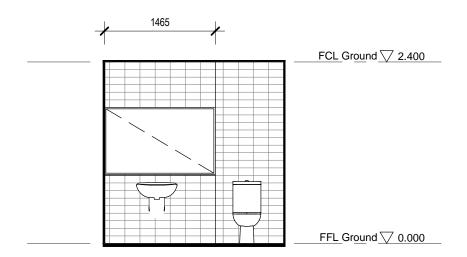

ELEVATION 2

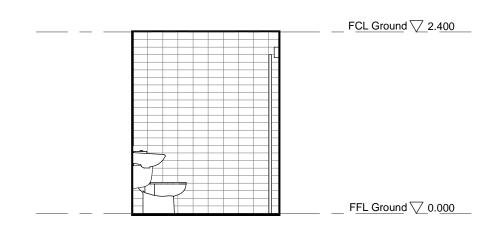

ELEVATION3

ELEVATION 4

EXISTING

AMENDMENTS

A 22/06/2021 INITIAL ISSUE B 23/07/2021 ISSUED FOR TENDER ARCHITECT

EMAA

Eric Martin & Associates
10/68 Jardine Street KINGSTON ACT 2604
Ph 02 6260 6395 Fax 02 6260 6413
emaa@emaa.com.au
Eric Martin Registered Architect
ACT 376 VIC 5150 NSW 5991 WA 1663 QLD 3391

CLIENT HIGH COURT OF AUSTRALIA PROJECT
HIGH COURT OF AUSTRALIA
LEVEL 1 PWDWC

DRAWING
TITLE
DETAIL ELEVATIONS ACCESSIBLE TOILET

NOTE: DO NOT SCALE OFF DRAWING

CADFILE
V:\Projects 2020\20017 High Court of Australia\l Tendering\20017 Level
HCA PWDWC TENDER.rvt


 SCALE
 DRAWN

 1:50@A3
 PM

 DATE
 ISSUE/ REVISION

 23/07/2021
 TENDER B

 CHECKED
 DWG No.

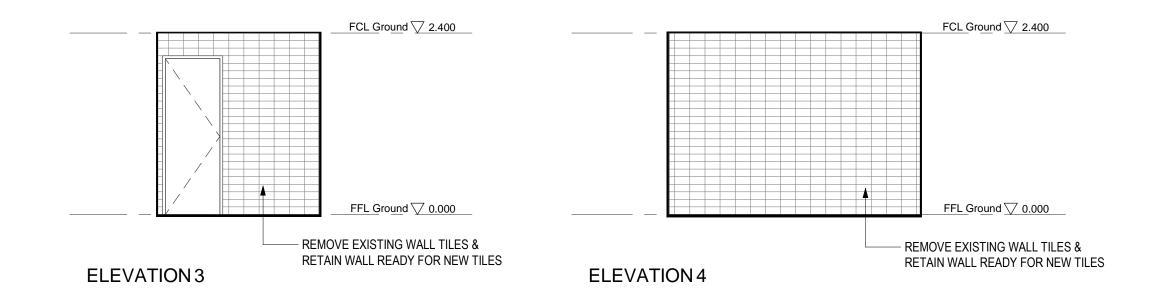

AMENDMENTS

A 22/06/2021 INITIAL ISSUE B 23/07/2021 ISSUED FOR TENDER ARCHITECT

EMAA

Eric Martin & Associates
10/68 Jardine Street KINGSTON ACT 2604
Ph 02 6260 6395 Fax 02 6260 6413
emaa@emaa.com.au
Eric Martin Registered Architect
ACT 376 VIC 5150 NSW 5991 WA 1663 QLD 3391

CLIENT HIGH COURT OF AUSTRALIA PROJECT
HIGH COURT OF AUSTRALIA
LEVEL 1 PWDWC

DRAWING
TITLE
DETAIL ELEVATIONS FEMALE REST ROOM
DEMOLITION

NOTE: DO NOT SCALE OFF DRAWING

CADFILE
V:Projects 2020/20017 High Court of Australia\l Tendering\20017 Level
HCA PWDWC TENDER.rvt


SCALE

DRAWN

1:50@A3 PM

DATE ISSUE/ REVISION TENDER B

CHECKED DWG No
EM 20017-A305/B

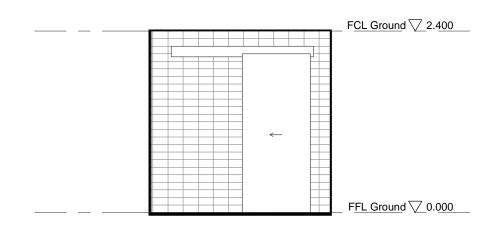

FCL Ground \bigvee 2.400 FFL Ground \bigvee 0.000

ELEVATION 1

ELEVATION 2



ELEVATION 3

ELEVATION 4

NOTE: NO DEMOLITION WORK TO BE CONDUCTED IN THIS ROOM

AMENDMENTS

A 22/06/2021 INITIAL ISSUE B 23/07/2021 ISSUED FOR TENDER ARCHITECT

Eric Martin & Associates 10/68 Jardine Street KINGSTON ACT 2604 Ph 02 6260 6395 Fax 02 6260 6413 emaa@emaa.com.au Eric Martin Registered Architect
ACT 376 VIC 5150 NSW 5991 WA 1663 QLD 3391

CLIENT HIGH COURT OF **AUSTRALIA**

HIGH COURT OF AUSTRALIA LEVEL 1 PWDWC

DRAWING TITLE


DETAIL ELEVATIONS PARENTS ROOM DEMOLITION


NOTE: DO NOT SCALE OFF DRAWING

CADFILE
V:\Projects 2020\20017 High Court of Australia\\ Tendering\20017 Level
HCA PWDWC TENDER.rvt

SCALE DRAWN 1:50@A3

DATE ISSUE/ REVISION 23/07/2021 TENDER B CHECKED DWG No 20017-A306/B

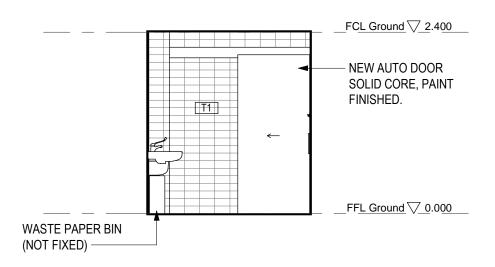


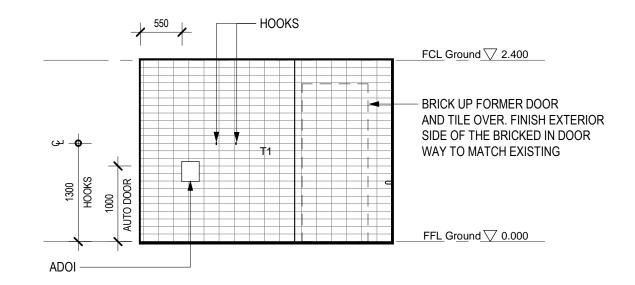


NOTE: FOR FIXTURES & FINISHES DETAILS REFER TO DRAWING A/315 & SCHEDULE OF FINISHES

NOTE: ALL DETAILS TO COMPLY WITH AS1428.1

ELEVATION 1

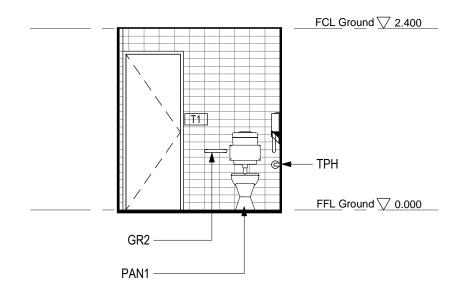

ELEVATION 2

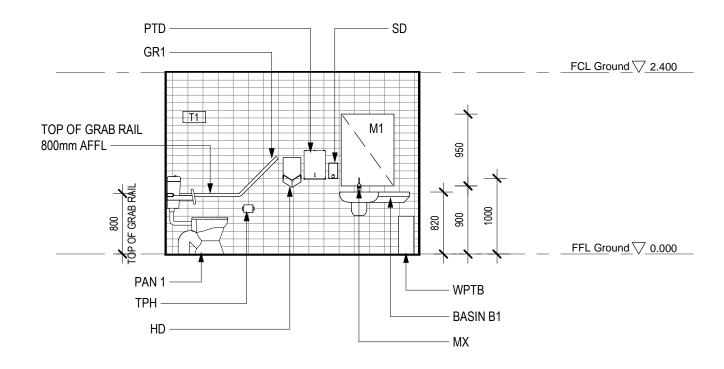

ELEVATION 3

ELEVATION 4

AMENDMENTS

- A 22/06/2021 INITIAL ISSUE
- B 06/07/2021 GENERAL AMENDMENTS C 23/07/2021 ISSUED FOR TENDER


Eric Martin & Associates
10/68 Jardine Street KINGSTON ACT 2604
Ph 02 6260 6395 Fax 02 6260 6413
emaa@emaa.com.au
Eric Martin Registered Architect
ACT 376 VIC 5150 NSW 5991 WA 1663 QLD 3391

ARCHITECT

CLIENT HIGH COURT OF AUSTRALIA

CADFILE
V:Projects 2020/20017 High Court of Australia\l Tendering\20017 Level
HCA PWDWC TENDER.rvt HIGH COURT OF AUSTRALIA SCALE DRAWN LEVEL 1 PWDWC 1:50@A3 DATE ISSUE/ REVISION DRAWING TITLE 23/07/2021 TENDER C CHECKED DWG No **DETAIL ELEVATIONS NEW PWDWC** ΕM 20017-A310/C

NOTE: DO NOT SCALE OFF DRAWING

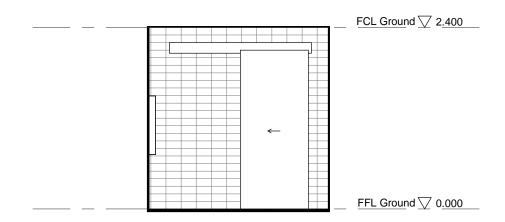


NOTE: FOR FIXTURES & FINISHES DETAILS REFER TO DRAWING A/315 & SCHEDULE OF FINISHES


NOTE:

ALL FIXTURES IN THE REALLOCATED PARENTS ROOM ARE TO REMAIN

ELEVATION 1 ELEVATION 2

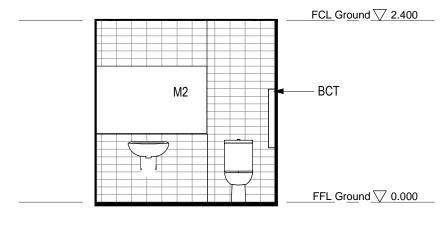



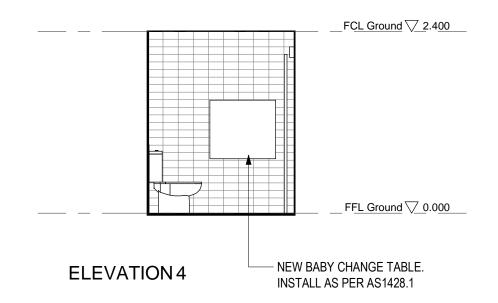

NOTE: DO NOT SCALE OFF DRAWING

AMENDMENTS
A 22/06/2021 INITIAL ISSUE
B 23/07/2021 ISSUED FOR TENDER

ARCHITECT

EMAA

Eric Martin & Associates
10/68 Jardine Street KINGSTON ACT 2604
Ph 02 6260 6395 Fax 02 6260 6413
emaa@emaa.com.au

Eric Martin Registered Architect
ACT 376 VIC 5150 NSW 5991 WA 1663 QLD 3391

CLIENT HIGH COURT OF AUSTRALIA PROJECT
HIGH COURT OF AUSTRALIA
LEVEL 1 PWDWC

DRAWING
TITLE
DETAIL ELEVATIONS NEW PARENTS ROOM

SAFETY IN DESIGN REPORT_	

NOTE: LIKELIHOOD - UNLIKELY, POSSIBLE, LIKELY, ALMOST CERTAIN. SEVERTY - MINOR, LOW, MODERATE. EXTREME

ARE THERE ANY ADDITIONAL HAZARDS AND RISKS NOT NORMALLY ASSOCIATED WITH THE TYPE OF WORK DETAILS IN THE DOCUMENTATION?

YES	Х	NO	
		·	

	SAFETY IN DESIGN REPORT - ARCHITECTURAL					
	RISK HAZARD	LIKELIHOOD OF RISK	CONSEQUENCES / SEVERITY	CONTROL MEASURES		
2	ASBESTOS	POSSIBLE	HIGH	CONFIRM WITH BUILDING MANAGMENT WERE ASBESTOS HAS BEEN IDENTIFIED AND ADVISE BUILDING MANAGEMENT WHERE ASBESTOS HAS BEEN IDENTIFIED IN THE COURSE OF UNDERTAKING BUILDING WORKS		
ARCHITECTURAL	CONDUCTING CONSTRUCTION WORK IN A BUILDING THAT WILL BE OPERATING	ALMOST CERTAIN	HIGH	COORDINATE WITH BUILDING MANAGEMENT TO CONFIRM PROCESS FOR ACCESSING SITE, REMOVING DEMOLISHED DEBRIS BRINGING INTO THE BUILDING NEW EQUIPMENT AND TO ALSO MINIMISE CONSTRUCTION NOISE		

HAVE YOU AND THE FOLLOWING PROJECT CONSULTANTS YES IDENTIFIED ANY SAFETY RISKS ASSOCIATED WITH THE

NO N

WORKS? IF SO, PROVIDE DETAILS.

NOTE: DO NOT SCALE OFF DRAWING

AMENDMENTS A 23/07/2021 ISSUED FOR TENDER ARCHITECT Eric Martin & Associates 10/68 Jardine Street KINGSTON ACT 2604 Ph 02 6260 6395 Fax 02 6260 6413 emaa@emaa.com.au

Eric Martin Registered Architect
ACT 376 VIC 5150 NSW 5991 WA 1663 QLD 3391

CLIENT HIGH COURT OF **AUSTRALIA**

CADFILE
V:\Projects 2020\20017 High Court of Australia\\ Tendering\20017 Level
HCA PWDWC TENDER.rvt HIGH COURT OF AUSTRALIA SCALE DRAWN LEVEL 1 PWDWC 1:100@A3 PMDATE ISSUE/ REVISION DRAWING TITLE 23/07/2021 TENDER A CHECKED DWG No SAFETY IN DESIGN REPORT ΕM 20017-A999/A

LEGEND EXISTING TO BE REMOVED OR ABANDONED DESCRIPTION EXISTING SANITARY DRAINAGE FIRE SERVICE COLD WATER

ABBREVIATIONS

- COLD WATER DUCTILE IRON CEMENT LINED DICL
- DOWN PIPE DRG DRAWING DISCONNECTOR TRAP
- EXISTING F/A FROM ABOVE
- F/B FROM BELOW FINISHED FLOOR LEVEL
- FINISHED GROUND LEVEL FIR HYDRANT
- FIRE HOSE REEI FIRE SERVICE FIXTURE UNITS
- FLOOR WASTE GRATED SUMP GATE VALVE
- HYDRANT HIGH LEVEL HOSE COCK
- HIGH DENSITY POLYETHYLENE HOT WATER
- INVERT LEVEL INSPECTION OPENING l/s
- LITRES PER SECOND MANHOLE NATURAL GAS
- 0/F OVER FLOW OVER FLOW RELIEF GULLY POLYETHYLENE SEWER MANHOLE SEWER RISING MAIN
- STORMWATER SWMH STORMWATER MANHOLE SV STOP VALVE ΤV TEMPERING VALVE T/A TO ABOVE T/B TO BELOW
- uPVC UNPLASTICISED POLYVINYL CHLORIDE VENT PIPE WM WATER METER

LEADERS

VERTICAL PIPES - FROM ABOVE SERVICE - PIPE SIZE — TO BELOW

FIRE SEALING OF PENETRATIONS NOTES

1. PENETRATIONS THROUGH FIRE RATED WALLS SHALL BE SEALED TO PROVIDE A TWO HOUR FRL TO AS1530 PART 4 - 2005.

WATER SUPPLY NOTES

- 1. ALL WORK SHALL BE CONSTRUCTED IN ACCORDANCE WITH AS3500.
- 2. COPPER TUBES AND FITTINGS SHALL COMPLY WITH AS1432 2004 TYPE "B" TUBES (WATER SUPPLY) AND TYPE "A" TUBES (FIRE SUPPLY).
- 3. ALL CONNECTIONS BETWEEN DISSIMILAR PIPE MATERIALS SHALL BE MADE WITH APPROVED MANUFACTURED FITTINGS.
- 4. SIZES SHOWN ARE INDICATIVE ONLY. THE PRESSURE AT ALL WATER OUTLETS ARE NOT TO EXCEED 500kPa IN ACCORDANCE WITH AS3500. PRESSURE REDUCTION IS TO BE ACHIEVED BY UTILIZING PRESSURE REDUCTION STATIONS.
- 5. ALL ISOLATION VALVES SHALL BE POSITIONED IN APPROVED ACCESSIBLE LOCATIONS. VALVES LOCATED IN DUCTS OR WALLS SHALL BE POSITIONED WITH APPROVED TYPE ACCESS COVERS.
- 6. ALL PIPE WORK SHALL BE CONCEALED. WHERE PIPE WORK IS EXPOSED IT SHALL BE CHROME PLATED.

SANITARY FIXTURES

FIXTURE No	FIXTURE NAME	No OFF - DELETED	No OFF – NEW
1	WATER CLOSET	1	-
2	ВАТН	-	-
3	BASIN	1	-
4	SHOWER	-	-
5	KITCHEN SINK	-	-
8	CLEANERS SINK	-	-
TOTAL		2	-


GENERAL NOTES

- 1. HYDRAULIC DRAWINGS SHALL BE READ IN CONJUNCTION WITH RELEVANT ARCHITECTURAL, STRUCTURAL, MECHANICAL, ELECTRICAL AND CIVIL WORKS DRAWINGS AND THE BUILDING HYDRAULICS SPECIFICATION.
- 2. ALL WORK MUST BE CARRIED OUT IN CONFORMITY WITH THE WATER AND SEWERAGE ACT 2000 AND THE WATER AND SEWERAGE REGULATIONS 2001.
- 3. ALL WORK SHALL BE CONSTRUCTED IN ACCORDANCE WITH AS3500.
- 4. THE LOCATIONS OF EXISTING SERVICES SHOWN ARE APPROXIMATE ONLY. EXACT LOCATION OF SERVICES SHALL BE VERIFIED PRIOR TO COMMENCEMENT OF WORK.
- 5. MINIMUM GRADES ON Ø100 AND Ø150 STORMWATER DRAINS SHALL BE 1.00% UNLESS SHOWN OTHERWISE.
- 6. ALL STORMWATER JUNCTIONS SHALL BE CARRIED OUT IN ACCORDANCE WITH TABLE "JUNCTION TYPES" SHOWN ON URBAN STORMWATER STANDARD DRAWING ST-0001.
- 7. COVER LEVELS ON MANHOLES AND SUMPS SHALL BE VERIFIED BY THE SUPERINTENDENT PRIOR TO THE CONSTRUCTION OF THE TOP SECTIONS OF THE STRUCTURES. THE CONTRACTOR SHALL ALLOW TO CONSTRUCT THE COVERS ON A SLOPE TO SUIT THE FINAL SURFACE SHAPES.
- 9. WHERE uPVC PIPES PENETRATE FIRE RATED WALLS OR SLABS, THEY SHALL BE PROVIDED WITH AN APPROVED FIRE RATED COLLAR, HAVING THE SAME FIRE RATING AS THE ELEMENT BEING PENETRATED.
- 10. WHERE SERVICES OTHER THAN uPVC PENETRATE CONCRETE OR MASONRY FIRE RATED BUILDING ELEMENTS, SEAL GAP BETWEEN SERVICES AND ELEMENT WITH AN APPROVED SILICON FIRE-STOP FOAM HAVING A FIRE RATING EQUAL TO THAT OF THE ELEMENT BEING PENETRATED.
- 11. SANITARY AND STORMWATER DRAINAGE SHALL BE SUPPORTED ON OR FROM SOLID GROUND IN ACCORDANCE WITH AS3500.
- 12. ALL DRAINAGE AND WATER SERVICES TO BE ABANDONED SHALL BE SEALED TO APPROVAL.
- 13. EXISTING SERVICE CONNECTION POINTS SHALL BE LOCATED ON SITE AND VERIFIED PRIOR TO COMMENCEMENT OF WORK.
- 14. EXISTING DRAINS UNDER NEW BUILDINGS SHALL BE RE-TESTED.
- 15. ORG LEVELS ARE TO BE IN ACCORDANCE WITH AS3500.2.2 CLAUSE 4.6.6.6 AND 4.6.6.7 AND ACTPLA PLUMBING NOTE 22.
- 16. THESE DRAWINGS ARE STRICTLY COPYRIGHT AND SHALL NOT BE COPIED OR AMENDED WITHOUT THE WRITTEN CONSENT OF SELLICK CONSULTANTS PTY LTD.
- 17. CONTRACTOR SHALL PROVIDE 'WORK AS EXECUTED' DRAWINGS AND PAY ALL ASSOCIATED FEES AT THE COMPLETION OF THE HYDRAULIC WORKS.

HYDRAULIC SERVICE MATERIALS NOTES


- 1. SANITARY DRAINAGE - ALL uPVC CLASS "DWV" SHALL BE TO AS1260, PARTS 1 TO 4 - 2002, SOLVENT WELDED JOINTS EXCEPT WHERE EXPANSION JOINTS ARE REQUIRED.
- 2. SANITARY PLUMBING - uPVC TYPE "DWV" SHALL BE TO AS1260, PARTS 1 TO 4 - 2002 SOLVENT
- WELDED JOINTS EXCEPT WHERE EXPANSION JOINTS ARE REQUIRED. 3. ALL INTERNAL AND EXTERNAL WATER SERVICES AND FITTINGS SHALL BE TYPE
- "B" COPPER TUBING TO AS1432 2004.
- 4. STORMWATER - ALL Ø100 AND Ø150 PIPES SHALL BE uPVC TO AS1260, PARTS 1 TO 4 - 2002, SOLVENT WELDED JOINTS EXCEPT WHERE EXPANSION JOINTS ARE REQUIRED

PIPING SYMBOLS

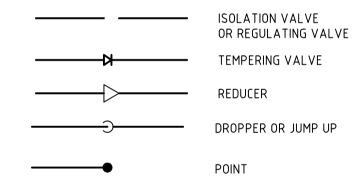

HEALTH AND SAFETY


- 1. THE MAIN CONTRACTOR AND ALL SUB-CONTRACTORS SHALL COMPLY WILL APPLICABLE HEALTH AND SAFETY CODES OF PRACTICE, GUIDANCE NOTES, AUSTRALIAN STANDARDS AND OTHER RELEVANT DOCUMENTATION.
- 2. CURRENT LEGISLATION REQUIRES THAT ALL PERSONS ARE TO CONSIDER THEIR ACTIONS OR LACK OF ACTION ON THE HEALTH AND SAFETY OF THEMSELVES AND OTHERS. ADVICE ON SAFETY LEGISLATION IS AVAILABLE FROM THE HEALTH AND SAFETY EXECUTIVE OFFICER NOMINATED FOR THE PROJECT.
- 3. THE MAIN CONTRACTOR AND ALL SUB-CONTRACTORS SHALL IDENTIFY HAZARDS OR WORK SEQUENCES THAT MAY BE A RISK TO THE HEATH AND SAFETY OF CONSTRUCTION WORKERS. IF POSSIBLE, AVOID THE RISK COMPLETELY, IF NOT ADVISE THE SITE MANAGEMENT FOR INCLUSION IN THE HEALTH AND SAFETY
- 4. THE MAIN CONTRACTOR AND ALL SUB-CONTRACTORS SHALL CARRY OUT RISK ASSESSMENTS FOR ALL OF THEIR ACTIVITIES AND WHERE NECESSARY INTRODUCE SUITABLE CONTROL MEASURES, OR PROVIDE PROTECTIVE CLOTHING TO MINIMISE THOSE RISKS. COPIES OF RISK ASSESSMENTS MUST BE PROVIDED TO THE SITE MANAGEMENT FOR INSPECTION.

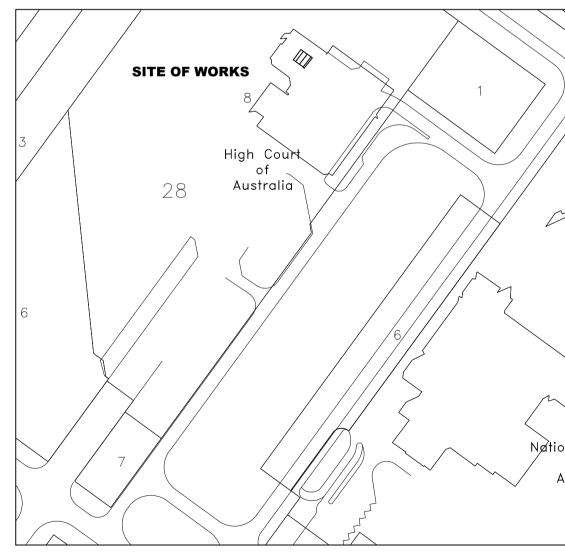

LOCALITY PLAN

GENERAL NOTES - GROUND LEVEL PWDWC


- 1. NO EXISTING DRAINAGE PLAN AVAILABLE. LOCATE AND CONFIRM EXISTING WC DRAINAGE ALIGNMENT PRIOR TO COMMENCEMENT OF WORKS.
- 2. CONFIRM EXISTING HOT AND COLD WATER ARE EXTENDED TO WC & BASIN.

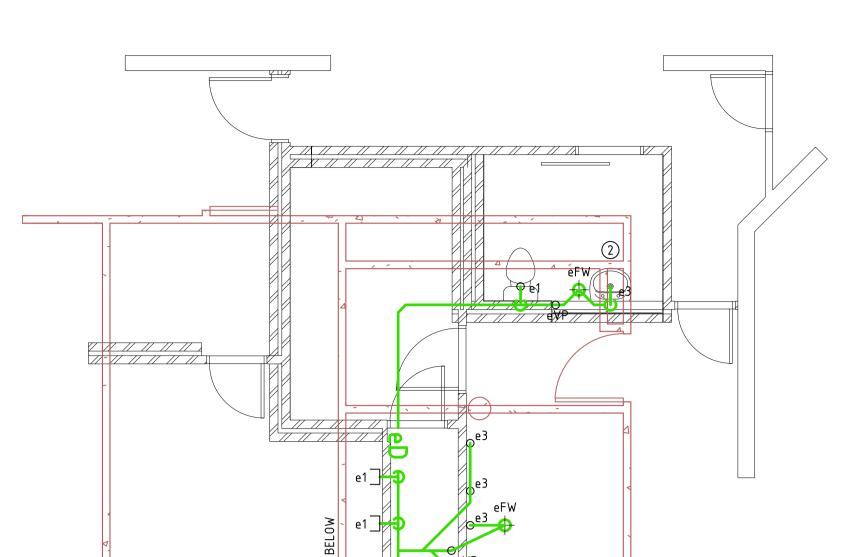


LEVEL 1 - EXISTING SERVICES

GENERAL NOTES - GROUND LEVEL PWDWC NEW WORKS

- LOCATE AND CONNECT TO EXISTING DRAINAGE DOWNSTREAM OF EXISTING WC.
- 2. LOCATE AND CONNECT TO EXISTING HOT & COLD WATER SERVICES TO EXISTING ACCESSIBLE TOILET ROOM 1.06 AND EXTEND TO NEW WC & BASIN INCLUDING NEW
- THERMOSTATIC MIXING VALVE. 3. THERMOSTATIC MIXING VALVE IN STEEL CABINET. REFER TO DETAIL A.

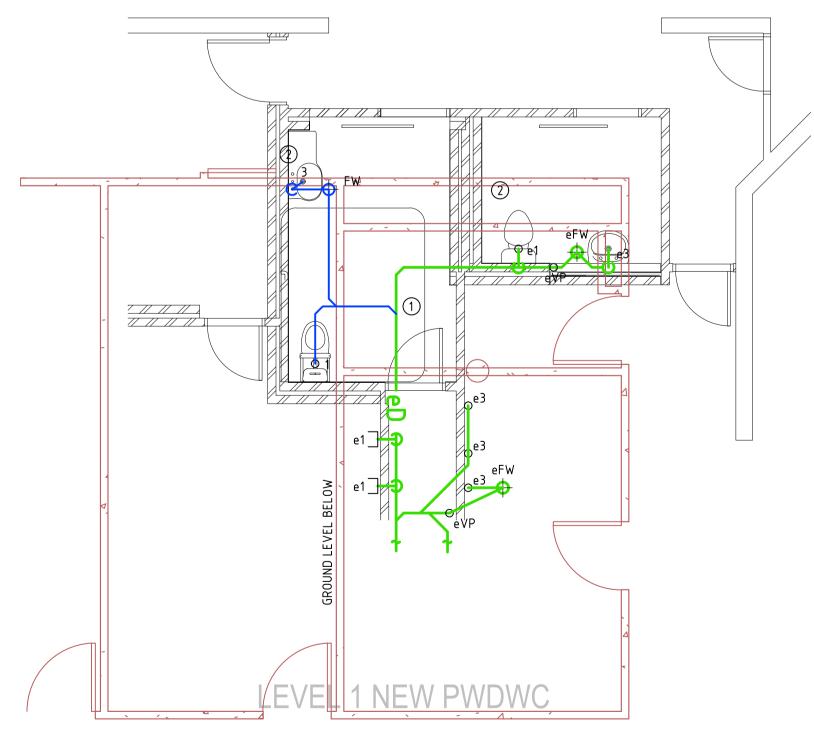

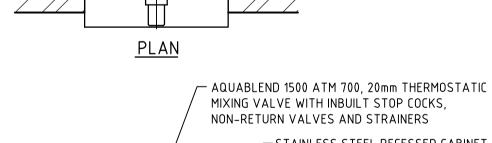

-STAINLESS STEEL RECESSED CABINET MODEL No. ATMS700R (LOCKABLE)

DRAINAGE PLAN NUMBER:

PLAN OF SANITARY DRAINAGE

DESIGNED TO AS3500

PLAN OF SANITARY DRAINAGE

DRAINAGE AND WATER SUPPLY

THE PLUMBING AND DRAINAGE IS DESIGN TO

AS/NZS 3500 PLUMBING STANDARDS.

ALL WORK MUST BE CARRIED OUT IN CONFORMITY

WATER AND SEWERAGE REGULATIONS 2001.

WITH THE WATER AND SEWER ACT 2000 AND THE

SECTION 28

OWNER HIGH COURT OF AUSTRALIA

BLOCK 15

SUBURB PARKES

FRONT ELEVATION



THERMOSTATIC MIXING VALVE SCALE 1:10

> PLUMBING PLAN APPROVED APPROVED BY REG. NUMBER

LEVEL 1 – GENERAL ARRANGEMENT

HYDRAULIC SERVICES LEVEL1 G/A

DRAWING NO. REV. H200

FOR TENDER

ISSUED FOR TENDER

SUE DESCRIPTION

ISSUED FOR TENDER REVIEW

01.07.20

DATE

DRAWN

HIGH COURT OF AUSTRALIA

EMA 10/68 Jardine Street KINGSTON ACT 2604 Ph 02 6260 6395 Fax 02 6260 6413 emaa@emaa.com.au Eric Martin Registered Architect
ACT 376 VIC 5150 NSW 5991 WA 1663 QLD 3391

sellick consultants STRUCTURAL CIVIL HYDRAULIC canberra sydney brisbane

HIGH COURT OF AUSTRALIA

02 6201 0200 www.sellickconsultants.com.au

CONSTITUTES AN INFRINGEMENT OF COPYRIGHT.

DO NOT SCALE OFF DRAWINGS VERIFY ALL DIMENSIONS ON SITE BEFORE COMMENCING WORK. COPYRIGHT: THE CONCEPTS AND INFORMATION CONTAINED IN THIS DOCUMENT ARE COPYRIGHT OF SELLICK CONSULTANTS. USE OR COPYING OF THIS DOCUMENT IN WHOLE OR IN PART WITHOUT WRITTEN PERMISSION

AUTHORISED BY PROJECT LOCATION PARKES **BLOCK 15 SECTION 28**

CHECKED BY

DATE

1. GENERAL SPECIFICATION NOTES

1.1 INFORMATION

THE CONTRACTOR IS TO FULLY INFORM THEMSELVES OF ALL ASPECTS OF THIS EXISTING INSTALLATION PRIOR TO TENDER & COMMENCEMENT OF CONSTRUCTION. UNDERTAKE A MANDATORY SITE INSPECTION TO ASSESS THE SCOPE OF DEMOLITION AND NEW WORKS

12 CODES RULES PERMITS FEES

ALL MATERIALS, SUPPLIES, AND ALL WORK INSTALLED SHALL COMPLY WITH THE CODES, STANDARDS, RULES AND REGULATIONS OF RELEVANT STATUTORY AUTHORITIES INCLUDING, BUT NOT NECESSARILY LIMITED TO:

- NATIONAL CONSTRUCTION CODE 2019
- AS 3000:2018 ELECTRICAL INSTALLATIONS (WIRING RULES)
- AS/NZS 2293 EMERGENCY LIGHTING AND EXIT SIGNS FOR BUILDINGS
- AS/NZS 3008 ELECTRICAL INSTALLATIONS SELECTION OF CABLES
 AS 3017 ELECTRICAL INSTALLATIONS TESTING CHIDELINES
- AS 3017 ELECTRICAL INSTALLATIONS TESTING GUIDELINES
- AS 4072 FIRE PENETRATIONS
- SUPPLY AUTHORITY REGULATIONS

MAKE ALL APPLICATIONS AND PAY ALL FEES REQUIRED TO COMPLY WITH RELEVANT AUTHORITY REQUIREMENTS, INCLUDING SELF-CERTIFICATION COSTS FOR ELECTRICAL INSPECTION.

1.3 DEFECTS LIABILITY

GUARANTEE ALL WORK AND MATERIALS AS TO QUALITY, WORKMANSHIP AND AGAINST DEFECTS, FOR A PERIOD OF TWELVE MONTHS FROM THE DATE OF ISSUE OF THE 'CERTIFICATE OF PRACTICAL COMPLETION'. DURING THIS PERIOD, PROMPTLY REPLACE ALL DEFECTIVE EQUIPMENT, FIXTURES AND MATERIALS AT NO ADDITIONAL COST.

1.4 PROVISIONS

PROVIDE THE FOLLOWING TO THE PROJECT MANAGER FOR REVIEW PRIOR TO COMMENCING INSTALLATION WORKS.

· LIGHTING TECHNICAL DATA

1.5 WORKMANSHIP

ALL WORKMANSHIP AND MATERIALS SHALL BE TO THE SATISFACTION OF THE PROJECT MANAGER. ALL MATERIALS SHALL BE NEW UNLESS OTHERWISE NOTED. ANY MATERIALS OR WORKMANSHIP, WHICH ARE CONSIDERED INFERIOR OR NON-CONFORMING BY THE PROJECT MANAGER SHALL BE REPLACED AT THE CONTRACTOR'S COST.

1.6 LICENSED ELECTRICAL CONTRACTOR

ALL WORKS SHALL BE UNDERTAKEN BY LICENSED ELECTRICAL CONTRACTOR'S, QUALIFIED AND EXPERIENCED IN THE TYPE OF WORK REQUIRED FOR THIS PROJECT.

1.7 RELATED ELECTRICAL WORKS

CO-ORDINATE AND CO-OPERATE WITH THE BUILDER AND OTHER TRADES (MECHANICAL, HYDRAULIC, ETC.) AS REQUIRED.

1.8 BACKGROUND

ELECTRICAL WORKS REQUIRED FOR THE REFURBISHMENT OF THE HIGH COURT TOILET AMENITY UPGRADE INCLUDE:

- ISOLATION, DISCONNECTION AND REMOVAL OF ALL ELECTRICAL SERVICES NOTED ON THE DRAWINGS.
- FINAL SUB-CIRCUITS TO ALL NOMINATED SERVICES.
- NEW GENERAL LIGHTING AS DOCUMENTED ON THE DRAWINGS.
- REW GENERAL EIGHTING AS DOCUMENTED ON THE DRAWINGS.
- TESTING AND COMMISSIONING
- PROVISION OF AS BUILT DOCUMENTATION
- A CONCURRENT PROJECT TO UPGRADE BUILDING EMERGENCY
 LIGHTING IS BEING UNDERTAKEN. NEW UNSWITCHED ACTIVE AND
 EMERGENCY LIGHTING TEST SWITCH SHALL BE PROVIDED BY THAT
 PROJECT

1.9 SCOPE OF WORK

THE SCOPE OF WORK INCLUDES THE DEMOLITION, SUPPLY, DELIVERY, INSTALLATION, TESTING AND SETTING TO WORK OF THE ELECTRICAL LIGHTING AND POWER SYSTEMS AS SHOWN ON THE DRAWINGS AND NOMINATED IN THE SPECIFICATION. SUPPLY ALL REQUIRED MATERIALS UNLESS OTHERWISE SPECIFIED. THE SCOPE OF WORK INCLUDES BUT IS NOT NECESSARILY LIMITED TO THE FOLLOWING:

1.9.1 LIGHTING

Plot Date: 12 August 2021 - 2:02 PM

- PROVIDE NEW LIGHTING AS SPECIFIED ON THE DRAWINGS. NEW LIGHTING IS TO MAKE USE OF EXISTING CUTOUTS AND SUPPLIES WHERE AVAILABLE.
- ALTERNATE LIGHT FITTINGS WILL NOT BE ACCEPTED WITHOUT APPROVAL FROM THE PROJECT MANAGER OR ELECTRICAL

- ENGINEER. PROVIDE PRODUCT SHEETS FOR ALL ALTERNATIVE FIXTURES.
- ALL LIGHTING CIRCUITS MODIFIED AND NEW, SHALL BE RCD PROTECTED. ENSURE THAT THERE ARE A SUITABLE NUMBER OF LUMINAIRES ON EACH CIRCUIT SO AS TO AVOID FALSE RCD TRIPPING DUE TO EARTH LEAKAGE FROM THE BALLAST/LUMINAIRE.
- MAXIMUM EARTH LEAKAGE CURRENT PER BALLAST FOR ALL NEW LUMINAIRES SHALL BE LESS THAN 0.3 mA.
- COORDINATE FINAL SET-OUTS FOR LIGHT FIXTURES FROM ON-SITE DIMENSIONED SETOUTS. COORDINATE ALL LUMINAIRE INSTALLATIONS WITH CEILING SETOUTS.

1.9.2 LIGHTING CONTROLS

- PROVIDE MOTION DETECTION CONTROLS TO LIGHTING AS NOMINATED ON DRAWINGS.
- CONNECT TO EXISTING LIGHT SWITCH
- ALL LIGHT SWITCHES SHALL HAVE CIRCUIT REFERENCE MARKED ON THE BACK OF THE FACEPLATES IN PERMANENT MARKER IF NOT ALREADY DONE.

1.9.3 GENERAL POWER

- SUPPLY AND INSTALL NEW POWER CONNECTIONS AS SHOWN ON THE DRAWINGS.
- RETICULATE POWER GENERALLY IN CEILING VOID, AND TERMINATED WITHIN THE EXISTING DISTRIBUTION BOARD DB-1A.
- PROVIDE CIRCUIT PROTECTION COMPLIANT WITH AS 3000. PROVIDE RCD PROTECTION WHERE REQUIRED UNDER THE AUSTRALIAN STANDARDS.
- TEST AND CERTIFY THE COMPLETE SYSTEM

1.9.4 OUTLETS AND ACCESSORIES

- SUPPLY, INSTALL AND CONNECT ALL NEW POWER OUTLETS AND ACCESSORIES AS SHOWN.
- ALL POWER OUTLETS SHALL HAVE CIRCUIT REFERENCE LABELS
 WITH BLACK LETTERS ON WHITE BACKGROUND FIXED BY INTEGRAL
 CIRCUIT DESIGNATION LABEL WINDOW ON SWITCH PLATE COVER.
 LABELS SHALL REFER TO THE SWITCHBOARD ORIGIN AND CIRCUIT
 BREAKER NUMBER. NEW SWITCHBOARD LABELS SHALL SHOW ID
 AND ORIGIN ON INTERNAL ESCUTCHEON. ALSO LABEL GPO WITH
 PERMANENT MARKER OR OTHER MEANS WHICH SHALL BE VISIBLE
 WHEN COVER PLATE IS REMOVED.
- PROVIDE AND INSTALL CIRCUIT BREAKERS INCLUDING 30 mA RCD's TO ALL GENERAL LIGHTING AND POWER CIRCUITS.
- COORDINATE OUTLETS AND CONNECTIONS TO DEDICATED EQUIPMENT WITH THE INSTALLER OF THAT EQUIPMENT. (AUTO DOOR)

1.9.5 EARTHING

- THE INSTALLATION BY THE CONTRACTOR SHALL BE EARTHED.
 EARTHING SHALL BE CARRIED OUT IN ACCORDANCE WITH THE
- RATHING STALL BE CARNIED OUT IN ACCORDANCE WITH THE
 RELEVANT SUPPLY AUTHORITY REQUIREMENTS AND AS/NZS 3000
 AND AS/CA S009.
- REUSE THE EXISTING MEN POINT FOR THE BUILDING.

1.9.6 CABLE SELECTION

- SUPPLY, INSTALL AND CONNECT ALL NEW POWER AND LIGHTING CABLING NECESSARY TO COMPLETE THE INSTALLATION.
- ALL POWER AND LIGHTING CABLES SHALL BE THERMOPLASTIC INSULATED (T.P.I) AND SHEATHED (T.P.S) 0.6/1.0 kV GRADE AS APPLICABLE WITH AS 5000.1. INSULATION SHALL BE V75 GRADE UNLESS OTHERWISE NOTED.
- LIGHTING SUB-CIRCUITS: 2.5 mm² MIN.
- GENERAL PURPOSE POWER CIRCUITS: MIN 2.5 mm².
- CONTROL CIRCUITS ETC: MIN 2.5 mm²
- FLEXIBLE CORDS: MIN 30/0.25 mm²
- SEGREGATE LV POWER CABLING AND COMMUNICATIONS/CONTROL CABLING TO AS 3000 AND AS/CA S009. PARTICULAR ATTENTION NEEDS TO BE PAID TO RETICULATION OF CABLING WITHIN SERVICES COLUMNS AND WORKSTATION SCREENS, TO ENSURE THAT SEGREGATION AND SEPARATION BETWEEN POWER AND COMMUNICATIONS CABLING IS MAINTAINED.
- ALL CABLING SHALL BE CONCEALED IN CEILING SPACES OR WALLS UNLESS INDICATED OR APPROVED OTHERWISE.
- ALL CABLING INDICATED OR APPROVED TO NOT BE IN A CONCEALED CEILING SPACE ARE TO BE ENCASED IN CONDUIT OR DUCT AND SECURELY MOUNTED IN FLAT FORMATION AGAINST A WALL OR SLAB IN ACCORDANCE WITH AS 3008.


1.9.7 TESTING AND COMMISSIONING


 CARRY OUT TESTING, OPERATING AND ADJUSTING THE SYSTEM AND EQUIPMENT, AND FOR FULLY INSTRUCTING THE PROJECT MANAGER OR THEIR REPRESENTATIVE IN THE OPERATION OF THE SYSTEM AND FOLIPMENT PROVIDE FULL OPERATOR'S MANUAL


- DEMONSTRATE TO THE PROJECT MANAGER AND NOMINATED REPRESENTATIVES THE FULL OPERATION OF THE LIGHTING CONTROL SYSTEM (INCLUDING ALL PRE-SETS AND CONTROLS OUTLINED WITHIN THIS DOCUMENT AND ALL MOTION SENSOR / TIMER CONTROLS PRESCRIBED) IN ACCORDANCE WITH THE PERFORMANCE REQUIREMENTS OUTLINED ON THE DRAWINGS.
- SUBMIT TEST REPORTS. PROVIDE THE PROJECT MANAGER WITH ALL TEST RESULTS, BOUND, FOR REVIEW. THE CERTIFICATE OF PRACTICAL COMPLETION WILL ONLY BE SIGNED AFTER THE COMPLETE TEST REPORTS HAVE BEEN REVIEWED. INCLUDE A HARD AND SOFT COPY OF THE FULL TEST REPORTS IN THE OPERATION AND MAINTENANCE MANUALS.
- CARRY OUT TESTING IN ACCORDANCE WITH AS 3000 CLAUSE 8.3 & 8.33 MANDATORY TESTS 8.3.10. OPERATION OF RCD'S.

1.9.8 AS-BUILT HARD COPY DRAWINGS AND MAINTENANCE MANUALS

- PROVIDE A FULL SET AND A 'DWG' (AUTOCAD LATEST VERSION) SET ON DISK OF AS-BUILT DRAWINGS, TO THE SATISFACTION OF THE PROJECT MANAGER, WITHIN 7 DAYS OF PRACTICAL COMPLETION. THE AS-BUILT DRAWINGS SHALL COMPREHENSIVELY REFLECT DETAILS OF ALL INSTALLED SYSTEMS AND COMPONENTS, AS DETAILED IN THE SCOPE OF WORK.
- PROVIDE TWO SETS OF OPERATION AND MAINTENANCE MANUALS, THE AIM OF THESE BEING TO PROVIDE A DETAILED UNDERSTANDING OF THE ITEMS OF EQUIPMENT AND ITS OPERATION, AN AID FOR TRAINING OF OPERATORS, A REFERENCE FOR FAULT DIAGNOSIS AND A FRAMEWORK FOR PREVENTIVE AND BREAKDOWN MAINTENANCE. THE MANUALS SHALL INCLUDE, AS A MINIMUM:
- NAME, ADDRESS, TELEPHONE AND FACSIMILE NUMBERS OF THE MANUFACTURER AND SUPPLIER OF ITEMS OF EQUIPMENT INSTALLED, TOGETHER WITH CATALOGUE LIST NUMBERS. ITEMS SHALL INCLUDE, BUT ARE NOT LIMITED TO ALL LIGHT FIXTURES, SWITCHES AND GPOS.
- INCLUDE SUCH DETAILS FOR ALL CONSULTANTS AND CONTRACTORS INVOLVED IN THE DESIGN AND CONSTRUCTION PHASES
- TECHNICAL DESCRIPTION AND MODES OF OPERATION OF THE SYSTEMS INSTALLED.
- PRODUCT LITERATURE FOR THE SYSTEMS INSTALLED AND CONTACT DETAILS FOR SUPPLIERS AND MANUFACTURERS' OF THESE SYSTEMS.
- CONTROL AND SWITCHING SEQUENCES AND FLOW DIAGRAMS FOR SYSTEMS INSTALLED, INCLUDING SAFETY FEATURES. ALSO PROCEDURES FOR OPERATING AND ADJUSTING CONTROL SYSTEMS.
- MANUFACTURERS' OPERATIONAL AND SAFETY LITERATURE, AS APPROPRIATE.
- EMERGENCY MAINTENANCE PROCEDURES, INCLUDING TELEPHONE NUMBERS FOR EMERGENCY SERVICES, AND AFTER HOURS CONTACTS FOR SUPPLIERS AND CONTRACTORS AND PROCEDURES FOR FAULT FINDING.
- STATUTORY CERTIFICATES OF COMPLIANCE FOR ALL ELECTRICAL AND COMMUNICATIONS WORK, COPIES OF MANUFACTURERS' WARRANTIES, CERTIFICATES FROM AUTHORITIES AND UTILITIES, PRODUCT CERTIFICATION, COPIES OF TEST CERTIFICATES, ETC.
- AS-BUILT DRAWINGS, SHOP DRAWINGS, SYSTEM SCHEMATICS ETC.
- COMMISSIONING RECORDS.

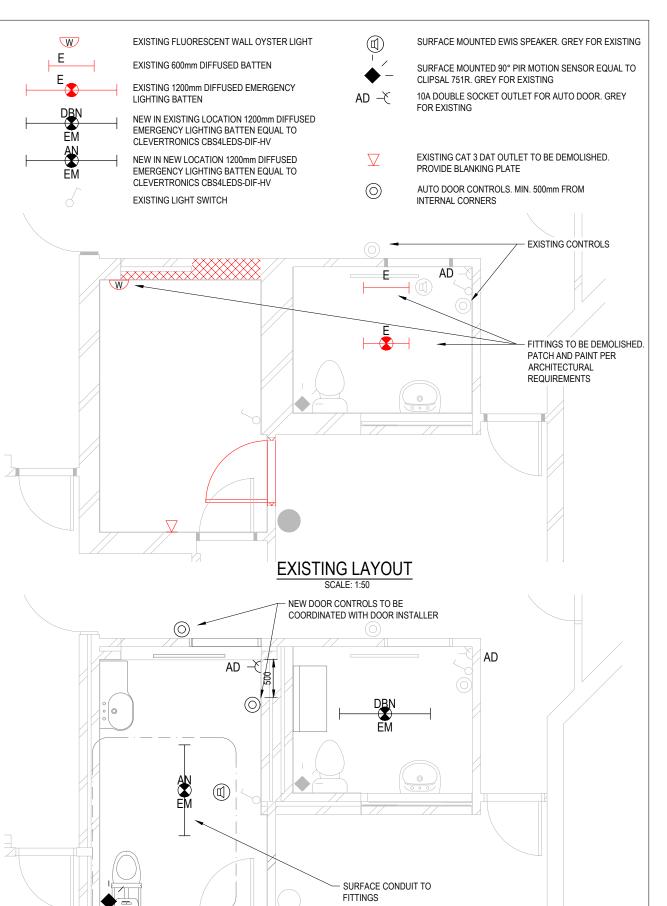

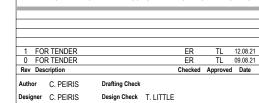

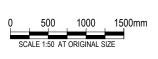





PROPOSED LAYOUT
SCALE: 1:50

Client HIGH COURT OF AUSTRALIA

Project GROUND FLOOR PWD WC


Status TENDER

PROPOSED LAYOUTS


Drawing ELECTRICAL SERVICES DEMO AND PROPOSED LAYOUTS

TENDER

12552620-F001

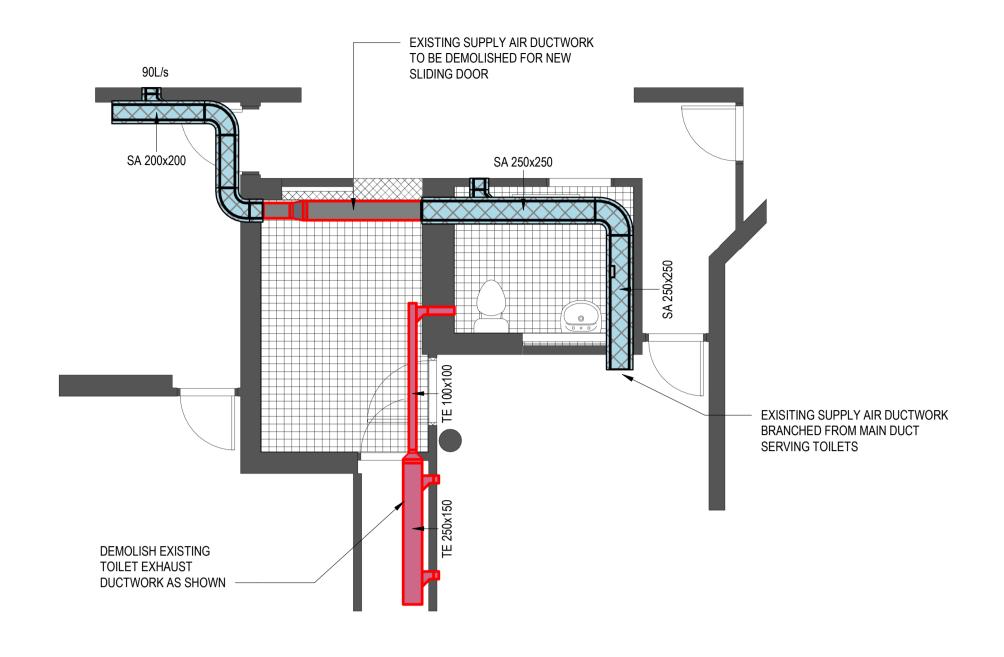

GROUND LEVEL - DEMOLITION

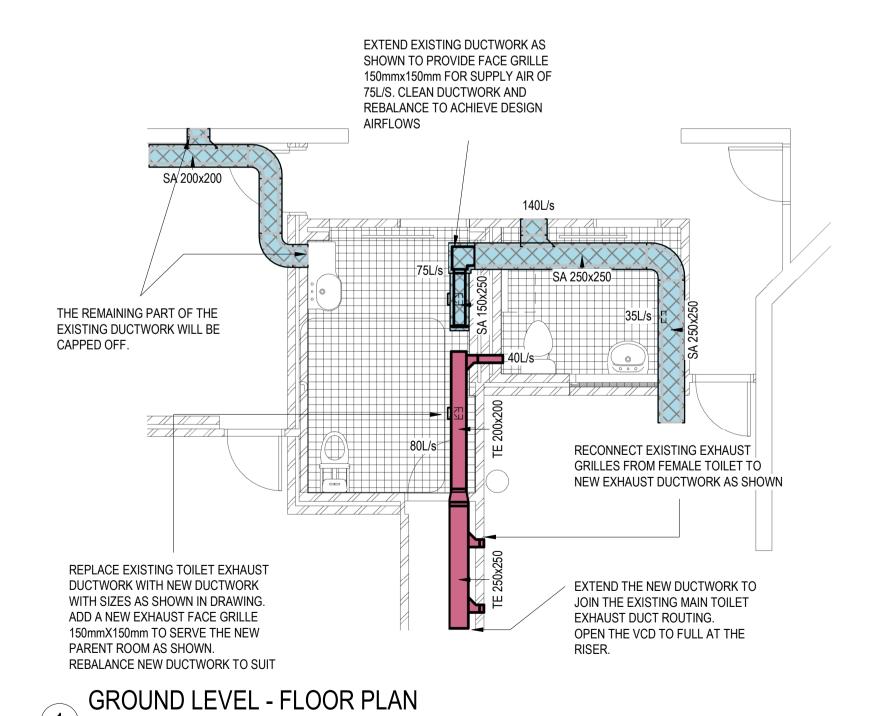

DESIGNED UNDER QUALITY SYSTEM CERTIFIED AS COMPLYING WITH ISO 9001 BY AN ACCREDITED CERTIFICATION BODY

© Copyright. This Document and Design remains the copyright of Steensen Varming (Australia) Pty Ltd and cannot be reproduced in any way without prior consent. The contractor shall verify all dimensions and levels on site as this is not a workshop drawing. The contractor shall refer any discrepancies to the engineer before proceeding with the work. This drawing shall be read in conjunction with other contract documents, drawings and project specifications. This file has been checked by an antivirus program with the latest update. However new viruses are discovered everyday we recommend that this file is rescanned upon receipt.

STATUS

FOR TENDER

NOTES

	AMENDMENTS					
REV	DESCRIPTION	DATE				
1	FOR TENDER	02.07.2021				
2	FOR TENDER	10.08.2021				

Copenhagen London Sydney Hong Kong

New York

8, 9 Castlereagh St.
Sydney, NSW, 2000, Australia
ABN 50 001 189 037
t:+61 / 02 9967 2200
e:info@steensenvarming.com


STEENSEN VARMING

PROJECT

HIGH COURT OF AUSTRALIA AMENITIES UPGRADE

MECHANICAL SERVICES
GROUND LEVEL - FLOOR PLAN AND
DEMOLITION PLAN

0	2.5m		5m	A 1
SUITABILITY	DRAWN	DESIGNED	CHE	CKED
	IR	FS	С	M
APPROVED	SCALE		NOR	THPOINT
DM	1 : 50			
PROJECT №.	DRAWING No.		R	EVISION
207028-5	SV-XX-00-DR	-M-2000		2

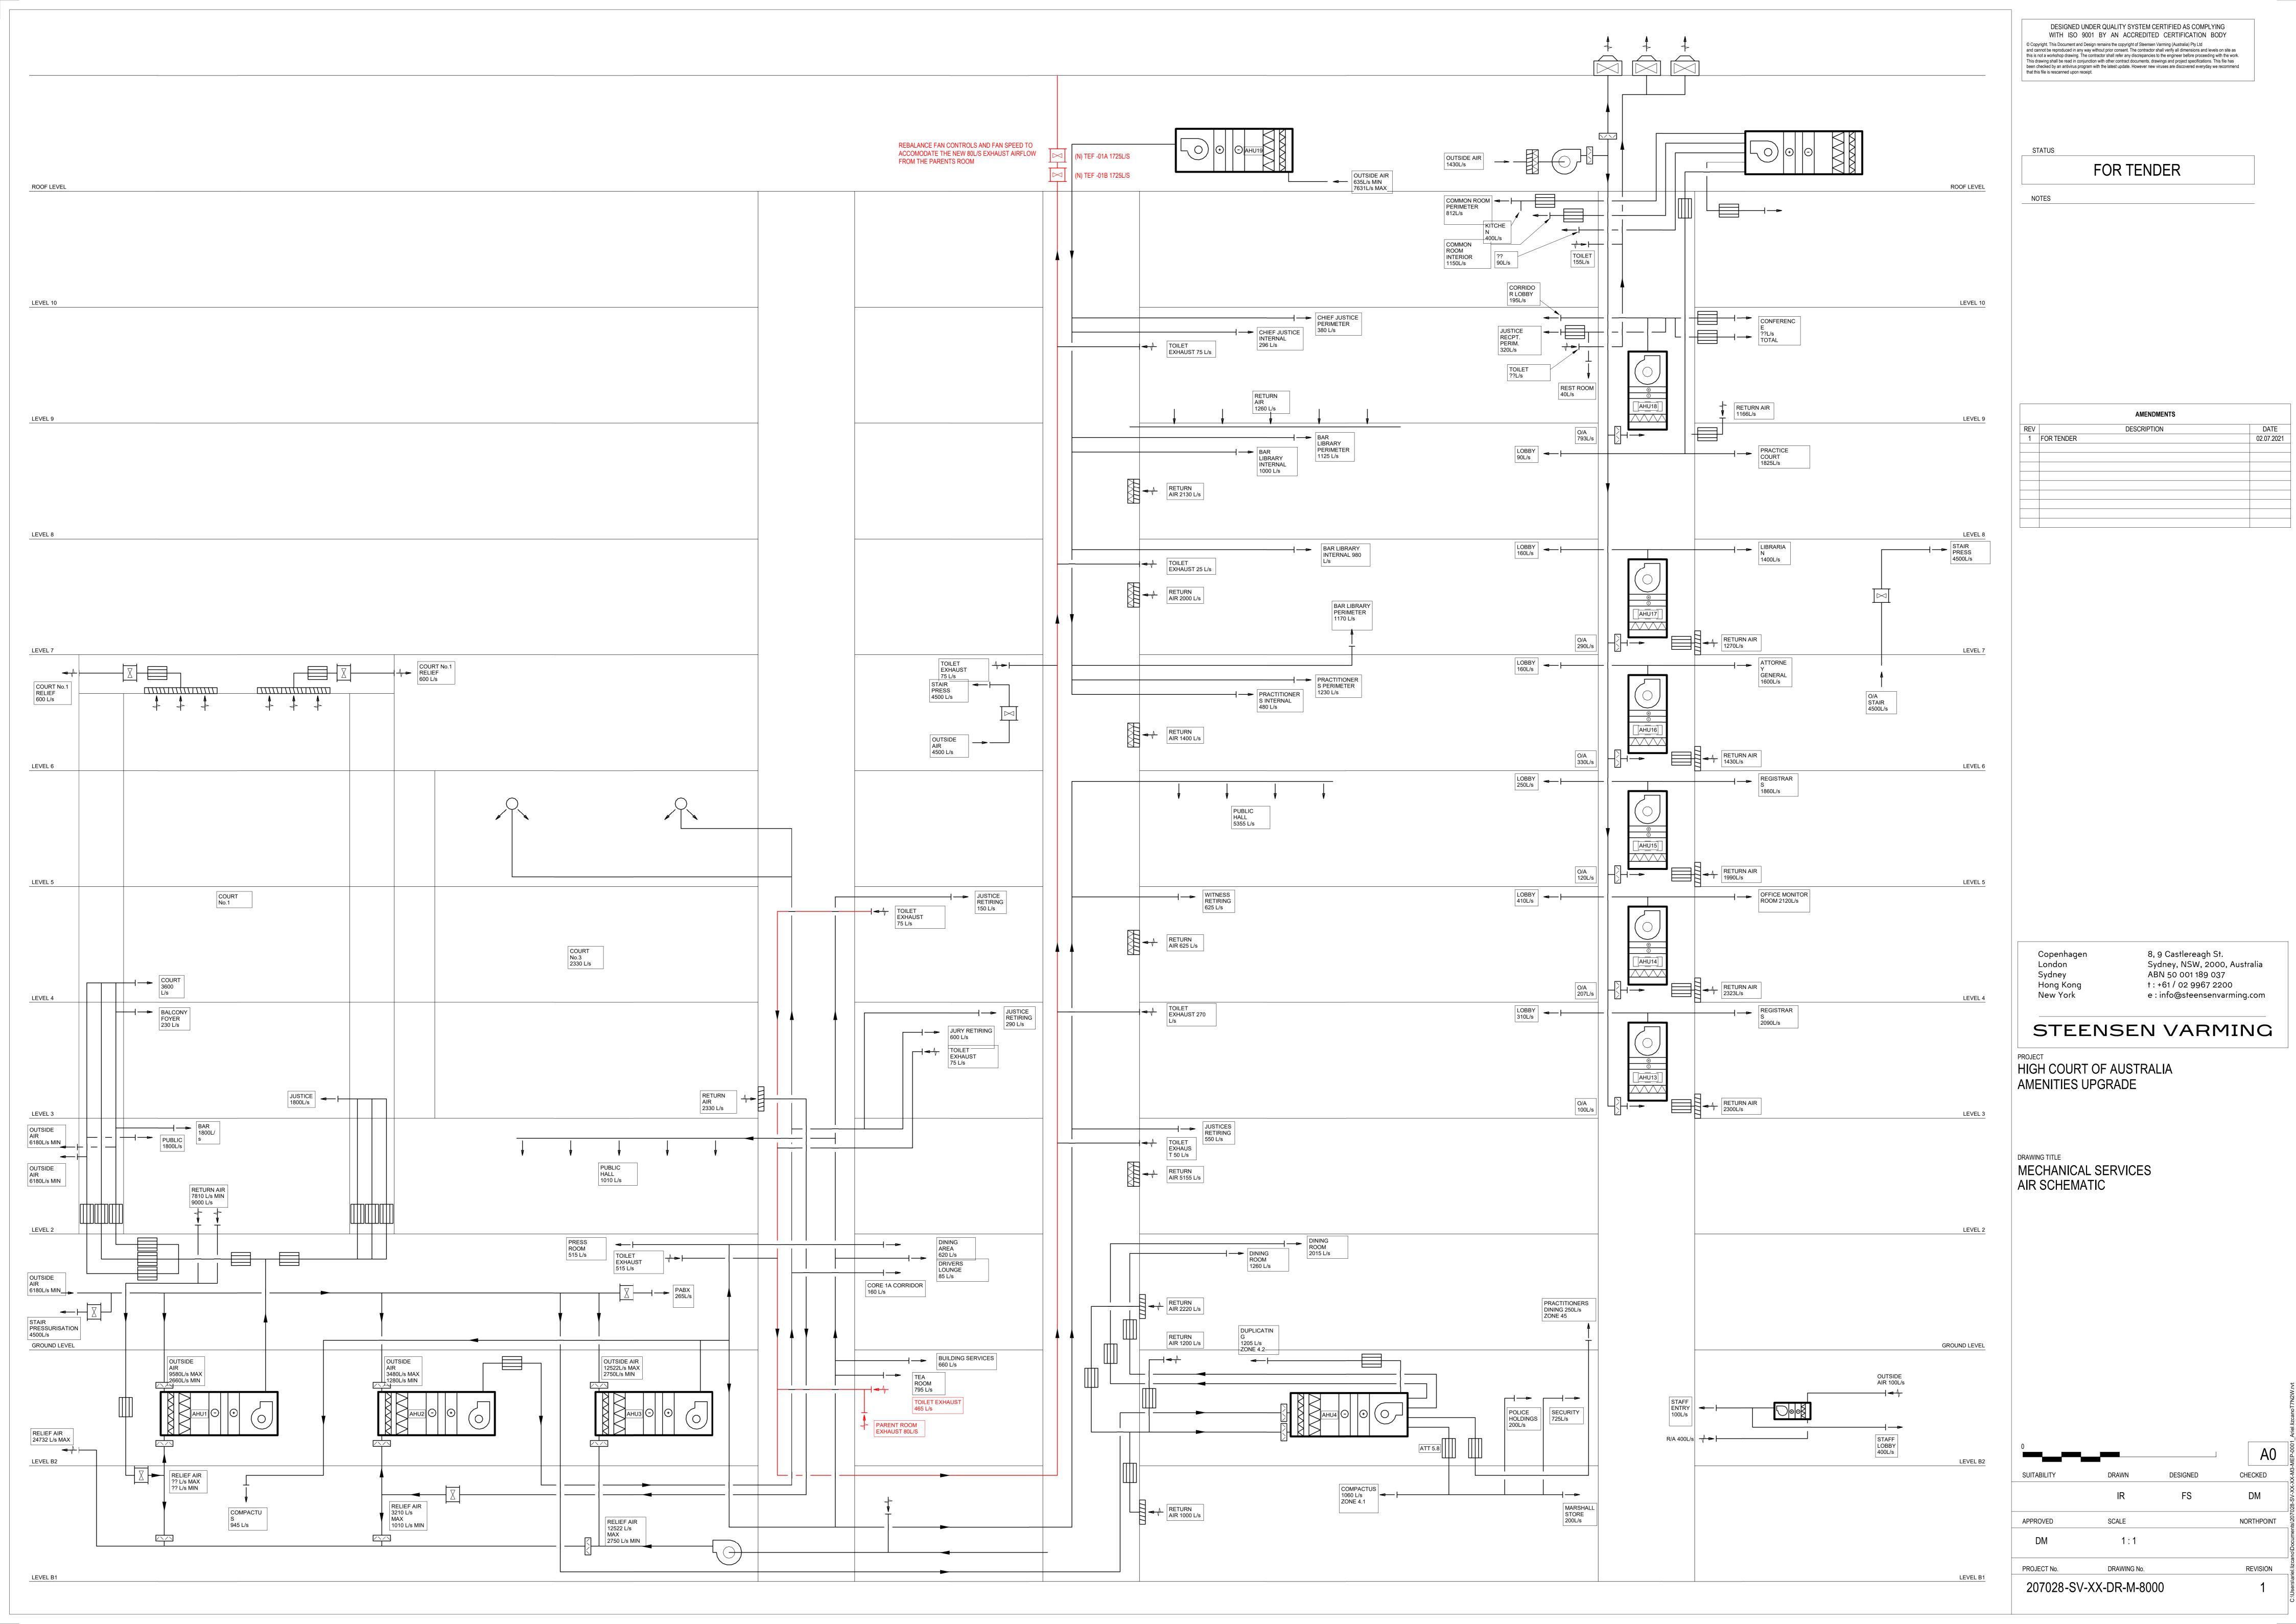


Mechanical Engineering Lighting Design Sustainable Design Electrical Engineering Copenhagen London Sydney Hong Kong New York GF 1, 17 Moore Street Canberra, ACT, 2601, Australia ABN 50 001 189 037 t:+61 / 02 6230 0502 e:info@steensenvarming.com

MECHANICAL ENGINEERING

STEENSEN VARMING



High Court of Australia – Amenities Upgrade Performance Specification

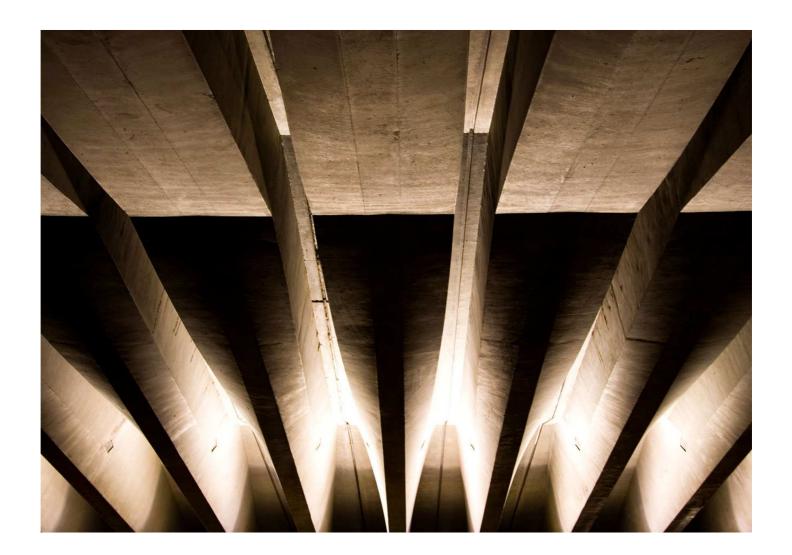

Mechanical Engineering Lighting Design Sustainable Design Electrical Engineering Copenhagen London Sydney Hong Kong New York GF 1, 17 Moore Street Canberra, ACT, 2601, Australia ABN 50 001 189 037 t:+61 / 02 6230 0502 e: info@steensenvarming.com

STEENSEN VARMING

Document Revision and Status

Date	Rev	Issue	Notes	Checked	Approved
02-07-2021	1	For Tender		DM	FS

Canberra July 2nd, 2021 Ref. No. 207028sp001

Faraan Shareef Senior Mechanical Engineer

faraan.shareef@steensenvarming.com (02) 9967 2200

Disclaimers and Caveats:

Copyright © 2021, by Steensen Varming Pty Ltd.

All rights reserved. No part of this report may be reproduced or distributed in any form or by any means, or stored in a database or retrieval system, without the prior written permission of Steensen Varming Pty Ltd.

This document is confidential and contains privileged information regarding existing and proposed services for the Building. The information contained in the documents is not to be given to or discussed with anyone other than those persons who are privileged to view the information. Privacy protection control systems designed to ensure the highest security standards and confidentiality are to be implemented. You should only re-transmit, distribute or commercialise the material if you are authorised to do so.

Page 2 / 11

Mechanical Engineering Lighting Design Sustainable Design Electrical Engineering Copenhagen London Sydney Hong Kong New York GF 1, 17 Moore Street Canberra, ACT, 2601, Australia ABN 50 001 189 037 t:+61 / 02 6230 0502 e: info@steensenvarming.com

STEENSEN VARMING

Table of Contents

1.0	General	4
1.1	The project	4
1.1.1	Description of the project	4
1.1.2	Description of the existing mechanical system	4
1.1.3	Redundant Equipment	7
2.0	Project Parties	8
2.1	Contractor	8
2.2	Mechanical Services Contractor	8 8 8
2.3	Principal	8
3.0	Mechanical Services Works	9
3.1	Scope of Works	9
3.2	Basis of the Mechanical Services Performance Specification	9
3.3	Scope of Mechanical Services	9
3.4	Other Trades	10
3.4.1	Building Trade	10
Standa	ards and Authorities	10
3.5	Documentation	11
3.5.1	General Requirements	11
3.6	Equipment	11
3.7	Grilles and Diffusers	11

GF 1, 17 Moore Street Canberra, ACT, 2601, Australia ABN 50 001 189 037 t:+61 / 02 6230 0502 e:info@steensenvarming.com

STEENSEN VARMING

1.0 General

1.1 The project

The project is the selected amenity upgrade of the High Court of Australia as part of the 2020/21 Upgrade.

1.1.1 Description of the project


This project consist of the upgrade of the following area:

Ground Floor Parent Amenities Room – There is a requirement to upgrade the existing PWD Room and the Parents Room because the overall dimensions of the PWD are not compliant and the access to the parents room is via the female toilets which will now be changed to sliding door.

1.1.2 Description of the existing mechanical system

Ground Floor Parent Amenity

The existing mechanical system for ground floor parent amenity comprises of the below exhaust ductwork reticulation. The room is used as a PWD Room, and the exhaust discharges through a toilet exhaust fan located on the roof. A centralized supply air fan provides the makeup air to the room.

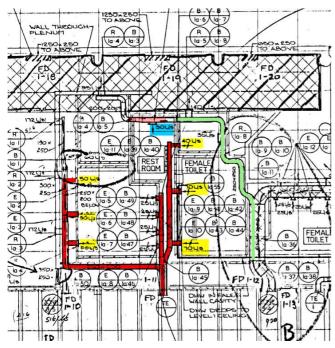

Page 4 / 11

Mechanical Engineering Lighting Design Sustainable Design Electrical Engineering Copenhagen London Sydney Hong Kong New York GF 1, 17 Moore Street Canberra, ACT, 2601, Australia ABN 50 001 189 037 t:+61 / 02 6230 0502 e: info@steensenvarming.com

STEENSEN VARMING

However, since the new proposed PWD room has modified amenities and the sliding door is full height, there will be modifications to the ventilation requirements and the duct routing.

The existing exhaust fan which is serving the toilet exhausts has a capacity of 1725l/s is of good condition and capacity as it was installed in the recent past, however contractor will be required to carry out the investigation to be able to rebalance the exhaust grilles to suit.



Image 2: Ground Floor Parent Toilet Supply & Exhaust Ducts

GF 1, 17 Moore Street Canberra, ACT, 2601, Australia ABN 50 001 189 037 t:+61 / 02 6230 0502 e:info@steensenvarming.com

STEENSEN VARMING

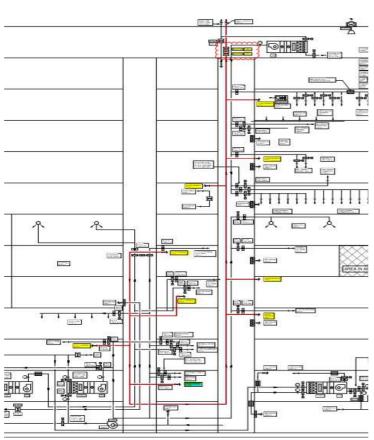


Image 3 : Air Schematic



Image 4 : Centralised Exhaust Fans

Mechanical Engineering Lighting Design Sustainable Design Electrical Engineering Copenhagen London Sydney Hong Kong New York GF 1, 17 Moore Street Canberra, ACT, 2601, Australia ABN 50 001 189 037 t:+61 / 02 6230 0502 e:info@steensenvarming.com

STEENSEN VARMING

Interruption of Existing Services

Where the work under the contract affects the continuity of existing services the Contractor shall arrange to have the work carried out at the least inconvenient time to the Principal. The work shall be organised to minimise the duration of inconvenience. This will mean out of hours work will need to be undertaken for elements of the Work or unless arranged otherwise with the Principal.

1.1.3 Redundant Equipment

All equipment and services made redundant through this project and required to be removed from its existing place of installation shall be removed from the site by the Contractor and shall be disposed of by the Contractor. All effort shall be made to recycle redundant equipment associated with this Contract. The Contractor shall provide a waste management plan together with records of relevant disposal and recycling activities.

All redundant mechanical services shall be stripped out to the extent indicated on the drawings. Redundant mechanical electrical services and control services shall be stripped back to source and associated ways in MCCs etc. shall be labelled as 'spare'.

Mechanical Engineering Lighting Design Sustainable Design Electrical Engineering Copenhagen London Sydney Hong Kong New York GF 1, 17 Moore Street Canberra, ACT, 2601, Australia ABN 50 001 189 037 t:+61 / 02 6230 0502 e:info@steensenvarming.com

STEENSEN VARMING

2.0 Project Parties

2.1 Contractor

The Contractor is referred here as the company engaged to provide the complete works including all materials, designs and provisions for any temporary works.

Where works are described as being provided by the Contractor in this specification they are expected to be included in the tender price for the Project whether or not they are included in other works descriptions for other sections of the Project. All works described in this specification as being provided by the Contractor are to include all materials and designs where required for the completion of the works.

2.2 Mechanical Services Contractor

The mechanical services contractor is referred to here when specific items are known to be applicable to the mechanical services associated with the Project.

The reference to works being undertaken by a mechanical services contractor does not obligate the contractor to engage a specific company associated with mechanical services to undertake the works. All works described as being by a mechanical services contractor are part of the overall works for the Project that the Contractor is contracted to provide.

2.3 Principal

The Principal for the Project is High Court of Australia. The Principal's Representative is Eric Martin Architects

Mechanical Engineering Lighting Design Sustainable Design Electrical Engineering Copenhagen London Sydney Hong Kong New York GF 1, 17 Moore Street Canberra, ACT, 2601, Australia ABN 50 001 189 037 t:+61 / 02 6230 0502 e:info@steensenvarming.com

STEENSEN VARMING

3.0 Mechanical Services Works

3.1 Scope of Works

This scope of works is the complete tender package for works described herein.

General

The divisions of the scopes for various trades are indicative only in this specification and does oblige the Contractor to divide the works as described. The divisions are based on standard practice for ease of division of the works for the Contractor.

3.2 Basis of the Mechanical Services Performance Specification

The mechanical services contractor shall design, supply and construct all the mechanical services required for the Project described herein. The items included in this specification are indicative of the minimum standards and requirements for the Project and do not limit the extent of works for all items required to complete the Project. The mechanical services contractor is to allow all components and associated works as required to complete the works whether stated or not in this specification or shown on the drawings.

3.3 Scope of Mechanical Services

The scope of works for this Project for the mechanical services includes but is not limited to the following:

Ground Floor Parent Amenity

- Detailed site inspection of the existing mechanical services including areas associated with this project, review of "AS" built drawings and Operating and Maintenance Manuals all located to enable to determine the extent of works.
- Existing supply ductwork must be demolished because of the new full height sliding door.
- Extend the existing supply air ductwork to the room as shown in the attached drawings M-2000.
- Supply and install a supply face grille, 150x150 to supply the required outdoor airflow, 75 L/s to the room.
- After removing the existing supply air ductwork, remaining piece of the ductwork needs to be capped which is serving the adjacent space as shown in M-2000.
- The exhaust ductworks must be replaced with a new size of the duct works requested and shown in the attached drawings M-2000.
- A 150x150 exhaust grille is required to be located on the exhaust duct work inside the room to exhaust of 80 L/s air flow.
- Extend the new exhaust ductwork to connect the main toilet exhaust ductwork.

Mechanical Engineering Lighting Design Sustainable Design Electrical Engineering Copenhagen London Sydney Hong Kong New York GF 1, 17 Moore Street Canberra, ACT, 2601, Australia ABN 50 001 189 037 t:+61 / 02 6230 0502 e:info@steensenvarming.com

STEENSEN VARMING

- Connect the existing exhaust grilles from female toilets to new exhaust duct as shown in M-2000.
- Open the VCD located at the riser fully open.
- Testing and Commissioning of the completed grilles within the toilet space.
- All air flows are to be balanced to within 5% of the final design air flows for the systems.
- The existing exhaust fan capacity to be reconfirmed on site which is serving the toilets from L1 to L9 is of good condition and capacity as it was installed in the recent past, contractor will be able to rebalance the exhaust grilles to suit.
- Labelling of all grilles with trifoliate labels.

3.4 Other Trades

Services provided by other trades are expected to be as the following sections. Coordination between all trades is expected to be included within the Contractor's scope of works.

3.4.1 Building Trade

■ Ceiling penetrations for all grilles, and diffusers

Standards and Authorities

All mechanical services shall be in accordance with all related statutory and other authorities including but not limited to the following:

- National Construction Code Series (BCA) 2019
- AS3000 Wiring Rules
- The Property Council of Australia.
- The Standards Association of Australia, AS1668.1:2015
- AS1668.2:2012 and AS3666.

Local Authorities such as:

- ACTEW Corporation
- ACT Fire Brigade.
- ACT Environment, Planning and Sustainable Development Directorate.
- ACT WorkCover.
- ACTPLA Planning Authority
- ACT NCA National Capital Authority

Any other Authority having jurisdiction over the installation to ensure that the machinery and installation will comply with the Rules and Regulations.

On completion of the installation and prior to final payment being made the Contractor is to arrange for each Authority having jurisdiction to inspect and check the contract works and where required by the Principal to obtain certificates from such Authority to the effect that the equipment, machinery and installation complies

Page 10 / 11

Mechanical Engineering Lighting Design Sustainable Design Electrical Engineering Copenhagen London Sydney Hong Kong New York GF 1, 17 Moore Street Canberra, ACT, 2601, Australia ABN 50 001 189 037 t:+61 / 02 6230 0502 e:info@steensenvarming.com

STEENSEN VARMING

with that Authority's requirements. These certificates are to be forwarded to the Principal.

The design and installation of the services must comply with the seismic constraint requirements in accordance with the AS1170.4 SAA Earthquake Code.

3.5 Documentation

3.5.1 General Requirements

The Contractor is required to provide from a suitable qualified Mechanical Services Contractor the following documentation:

- Shop drawings of the proposed works for review by the Principal & Engineer
- Equipment selection manufactures data for grilles
- System pressure calculations of all ducted existing AHU SA and RA fans
- Ductwork design to AS4254 Pt1 & 2. 2012
- As-built documentation of the mechanical services and other works completed as part of the Project that relate to the mechanical services
- Operation and maintenance manuals of the works (if any) including the following:
- Equipment and material schedules
- Supplier schedules
- As-built documentation
- Commissioning results
- Installation certificates of the mechanical services
- 12months Services or same as head contract.

3.6 Equipment

3.7 Grilles and Diffusers

For this project the exhaust & supply air grilles shall be retained by the MSC and shall be inspected and checked to be equal to design spec.

All grilles to have removable cores and

All grilles to be painted as per the architectural requirements.